


Plant Legend

| Aark | Botanical Name | Common Name | Water Use | Type 1. Qu | antity |
|------|-------------------------------|------------------------|--------------|-----------------|---------|
| 1 | Achillea 'Terra Cotta' | yarrow | Low .03 | Ground Cover | 18 tota |
| 2 | Achillea borealis | island pink yarrow | Low .03 | Ground Cover | |
| 3 | Achillea millifolium | yarrow | Low .03 | Ground Cover | |
| 4 | Cneorum tricoccon | Olive | Moderate | Tree | 2 |
| 5 | Arctostaphylos uva-ursi | Wood's Compact' | Low .03 | Shrub | 13 |
| 6 | Baccharis pilularis | coyote bush | Low .03 | Shrub | 2 |
| 7 | Bouteloua curtipendula | sideoats gramma | Very Low .01 | Oramental grass | 10 |
| 8 | Calandrinia spectabilis | rock purslane | Low .03 | Schrub | 10 |
| 9 | Aster chilensis | dwarf California aster | Moderate .05 | Small tree | |
| 10 | Artichoke | Artichoke | Edible NA | Flowering | 6 |
| 11 | Pear Tree | Pear Tree | Moderate .05 | Tree | |
| 12 | Prunus ilicifolia ssp. lyonii | Catalina cherry | Low .03 | Tree | |
| 13) | Erigeron karvinskianus | Santa Barbara Daisy | Low .03 | Ground cover | 85 |
| 14) | Festuca californica | California fescue | Low .03 | Oramental grass | 30 |
| 15 | Fragaria spp. | Strawberries | Edible | Ground cover | 30 |

Source: WULCOS IV UC California Agriculture and Natural Rescources



Undisturbed area

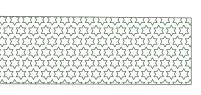


Rain Garden



Gabion Wall



Vegetable Garden

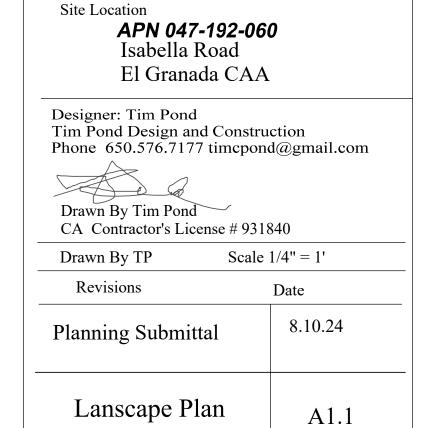

Alexis and Sarita Genest

530 Isabella Rd,

650.454.5889

alexis_genest@yahoo.com

Half Moon Bay, CA 94019

OWNER:

Model Water Efficient Landscape Ordinance Prescriptive Compliance Option (Required Information and Signature, and prescriptive measures)

Project Address unassigned 3009 sq ft of project landscaping. no turf on the project Private residence No irrigation, hand water only. CCWD Project Applicant: Tim Pond. Owner responsible for Maintenance


Mandatory Measures:

Incorporate compost at a rate of at least four cubic yards per 1,000 square feet to a depth of six inches into landscape area (unless contra-indicated by a soil test); Plant material shall comply with all of the following; For residential areas, install climate adapted plants that require occasional, little or no summer water (average WUCOLS plant factor 0.3) for 75% of the plant area excluding edibles and areas using recycled water; For non-residential areas, install climate adapted plants that require occasional, little or no summer water (average WU COLS plant factor 0.3) for 100% of the plant area excluding edibles and areas using recycled water;


(8) A minimum three inch (3") layer of mulch shall be applied on all exposed soil surfaces of planting areas except in turf areas, creeping or rooting groundcovers, or direct seeding applications where mulch is contraindicated.

"I agree to comply with the requirements of the prescriptive compliance option to the MWELO".



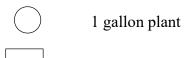

5 Gallon Plant

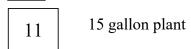


Direction of surface flow of water




(Direct water away from buildings and neighboring properties) Down Spout

Vegetable Garden 4" SDR 35 piping for rainwater

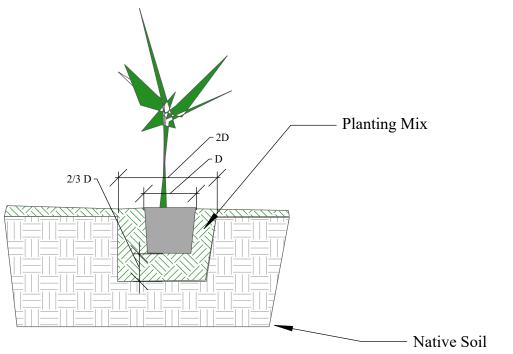

Typical Planting Detail




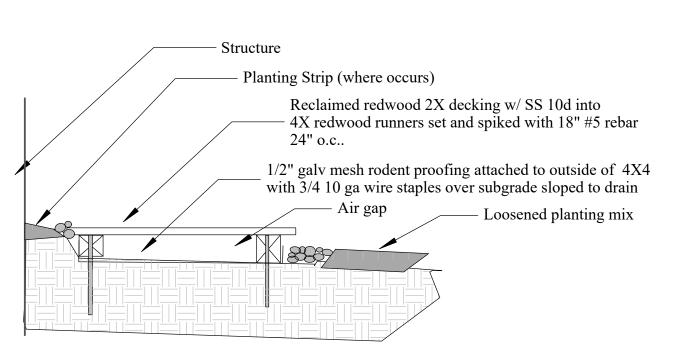






Permeable Walkway or deck at Building

LEGEND

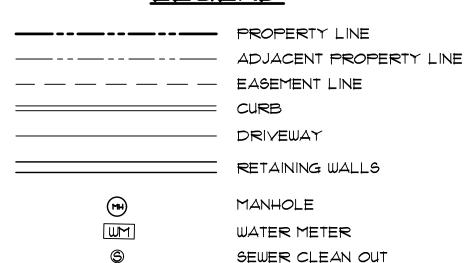

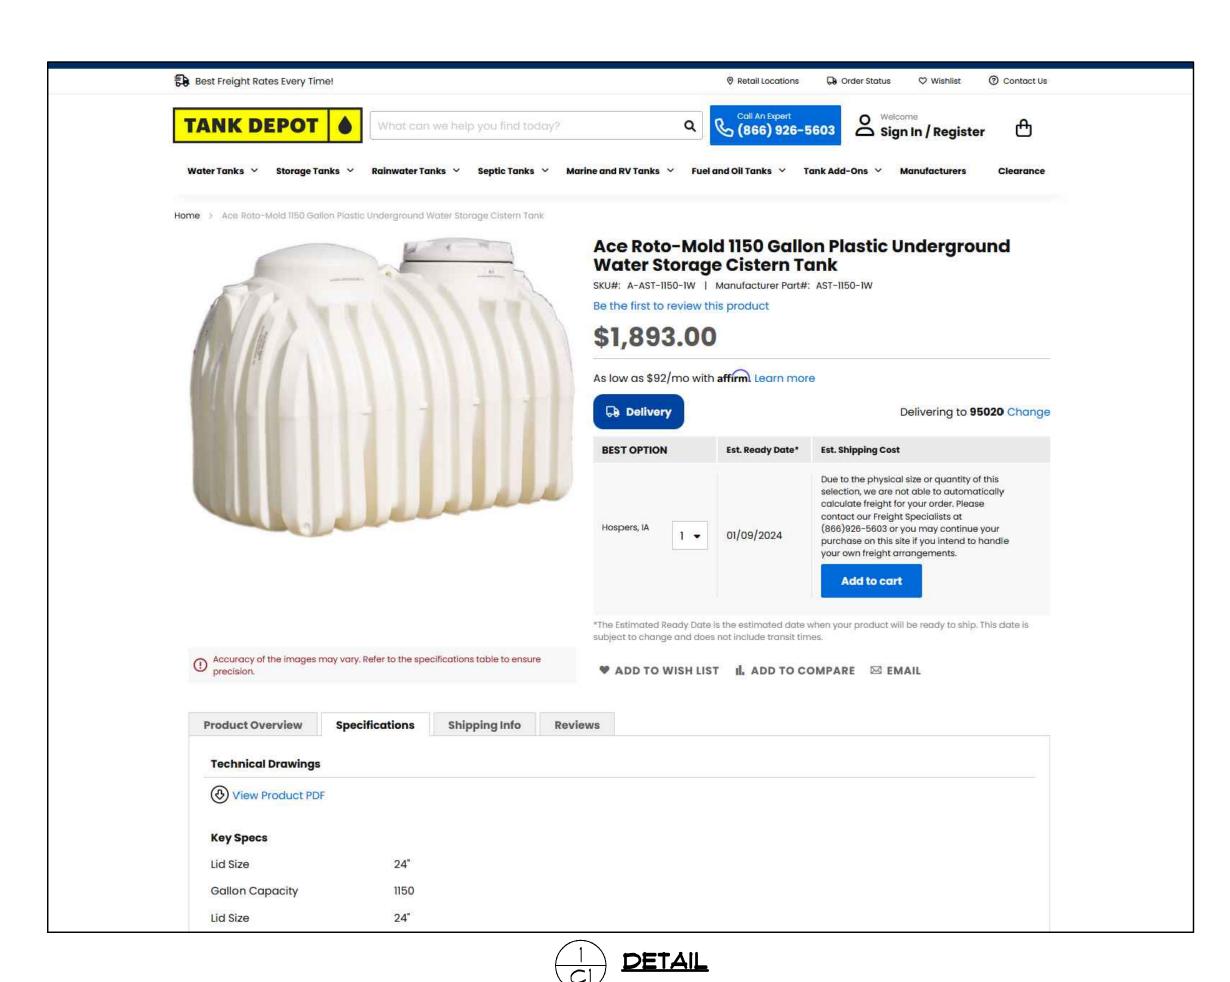

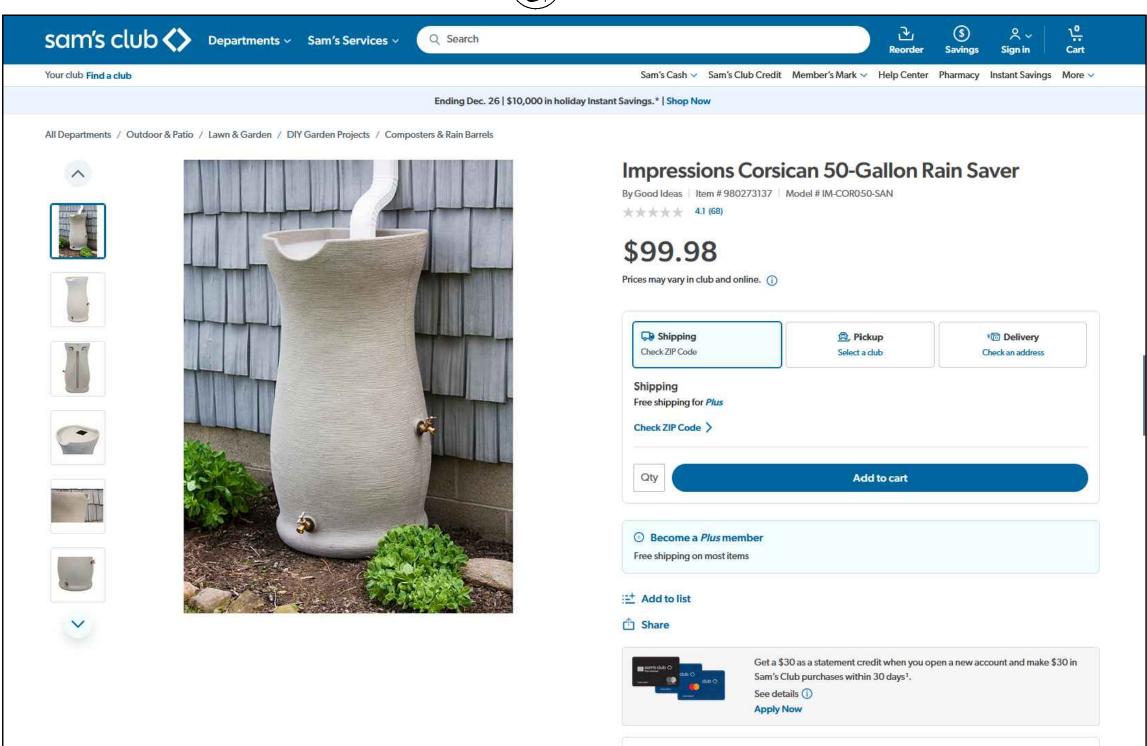

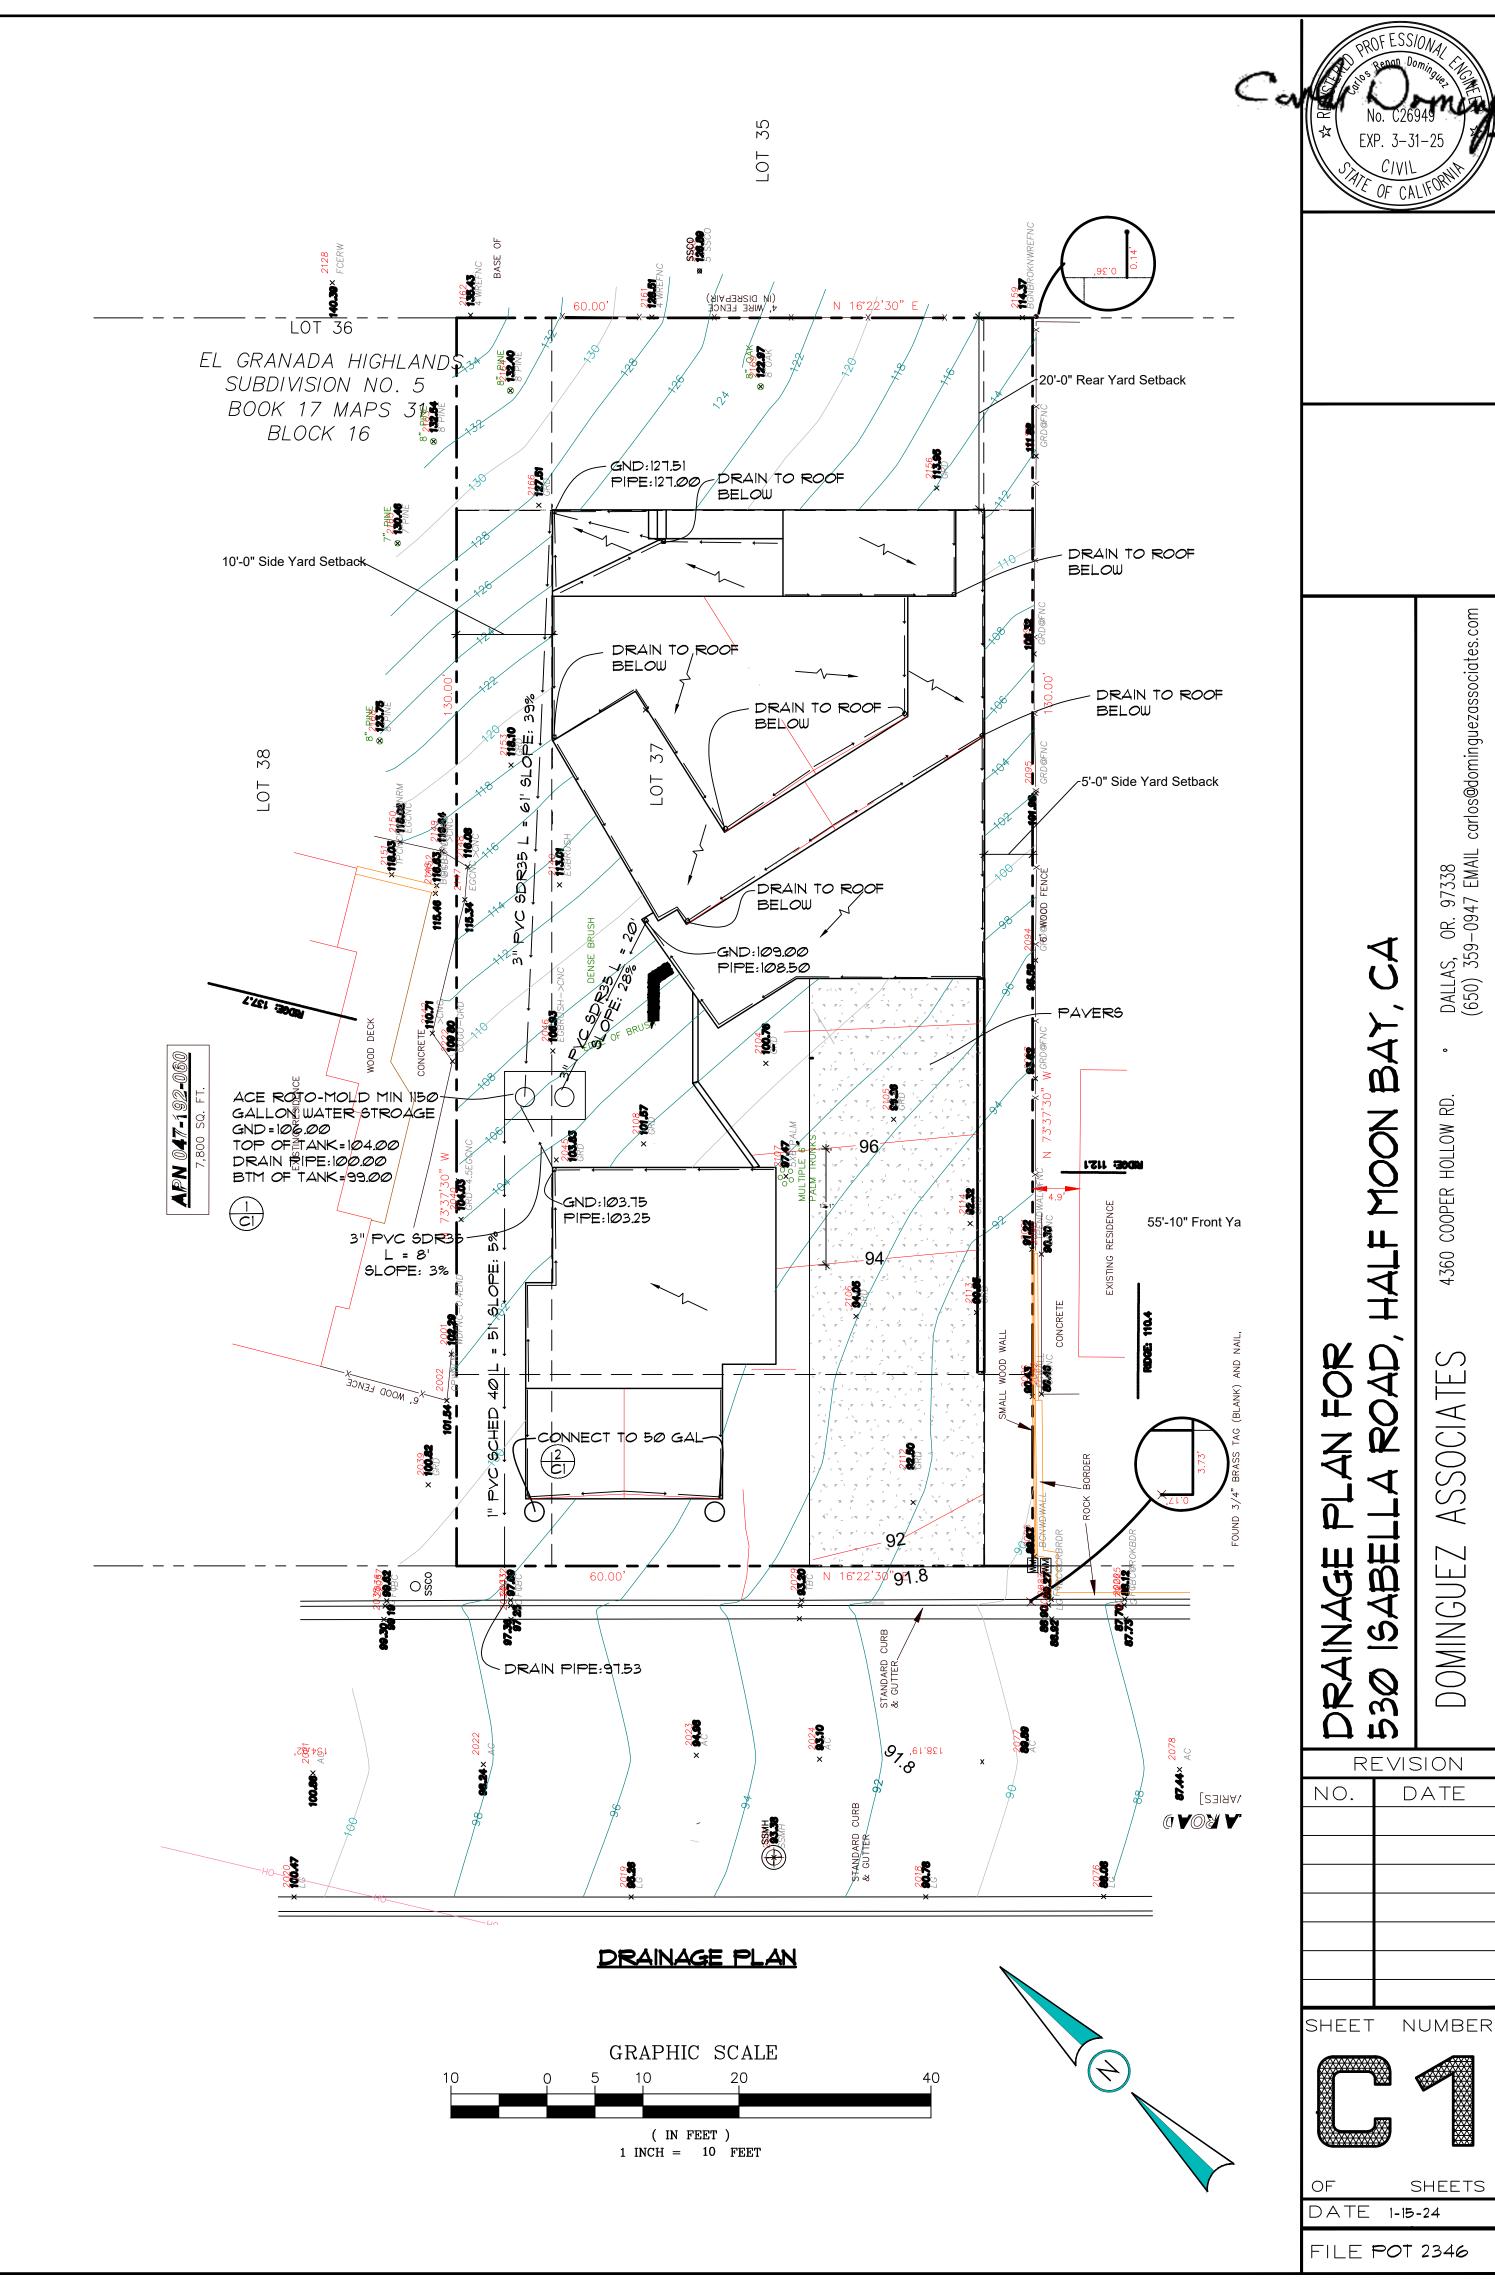

OR. 97338 1-0947 EMAIL

4

4

SOCIATE

DOMINGUEZ

REVISION

DATE



EROSION CONTROL NOTES


FIBER ROLE INSTALL AT LOCATIONS SHOWN. AFIX AS SHOWN IN DETAIL 1/C2

FOR CONSTRUCTION DURING DRY SEASON, ALL EXPOSED SURFACES SHALL BE WETTED PERIODICALLY TO PREVENT SIGNIFICANT DUST.


BETWEEN OCT 15 AND APRIL 15 ALL EXPOSED SOIL SHALL BE PROTECTED FROM EROSION AT ALL TIMES. SUCH PROTECTION SHALL CONSIST OF COIR LOGS, AS SHOWN.

ALL STOCKPILED SOIL SHALL BE COVERED DURING PERIODS OF RAIN.


BEFORE COMPLETION OF PROJECT ALL EXPOSED OR DISTURBED SURFACES SHALL BE PERMANENTLY PROTECTED FROM EROSION, USING JUTE NETTING AND/OR SEED.

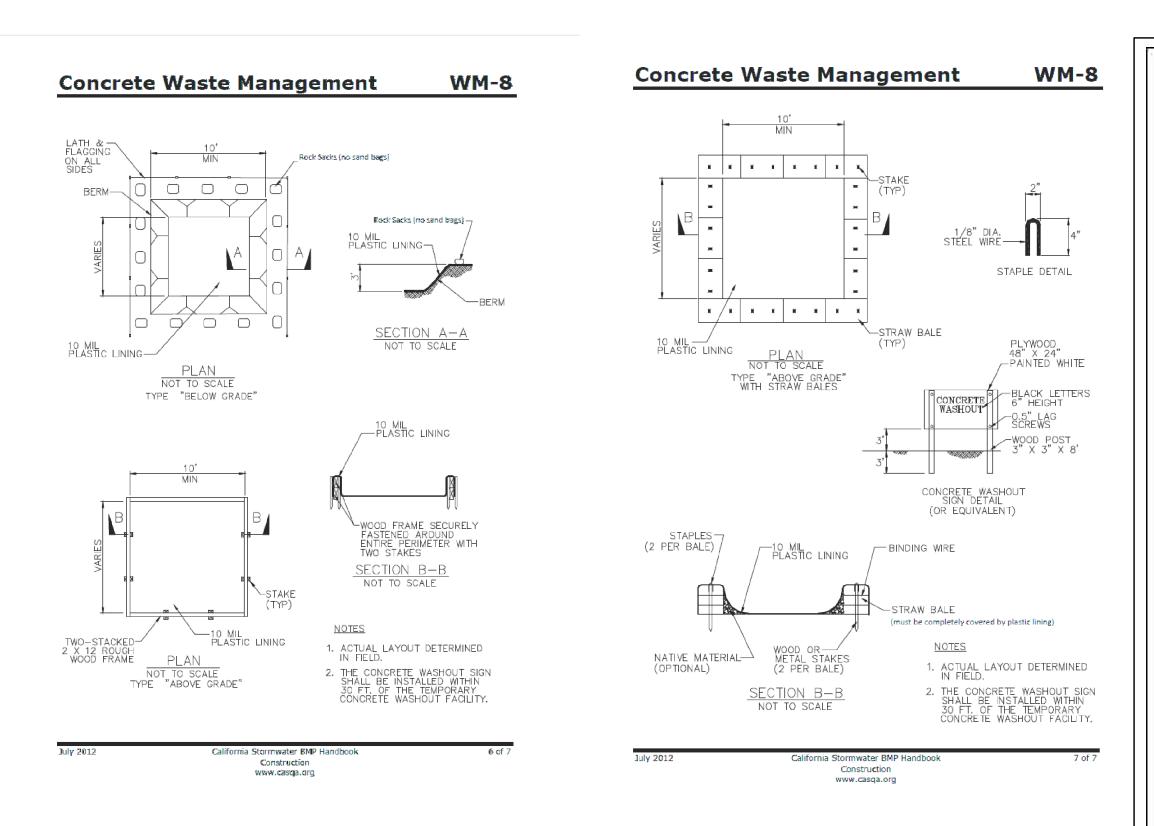


2 CONCRETE WASTE MANAGEMENT

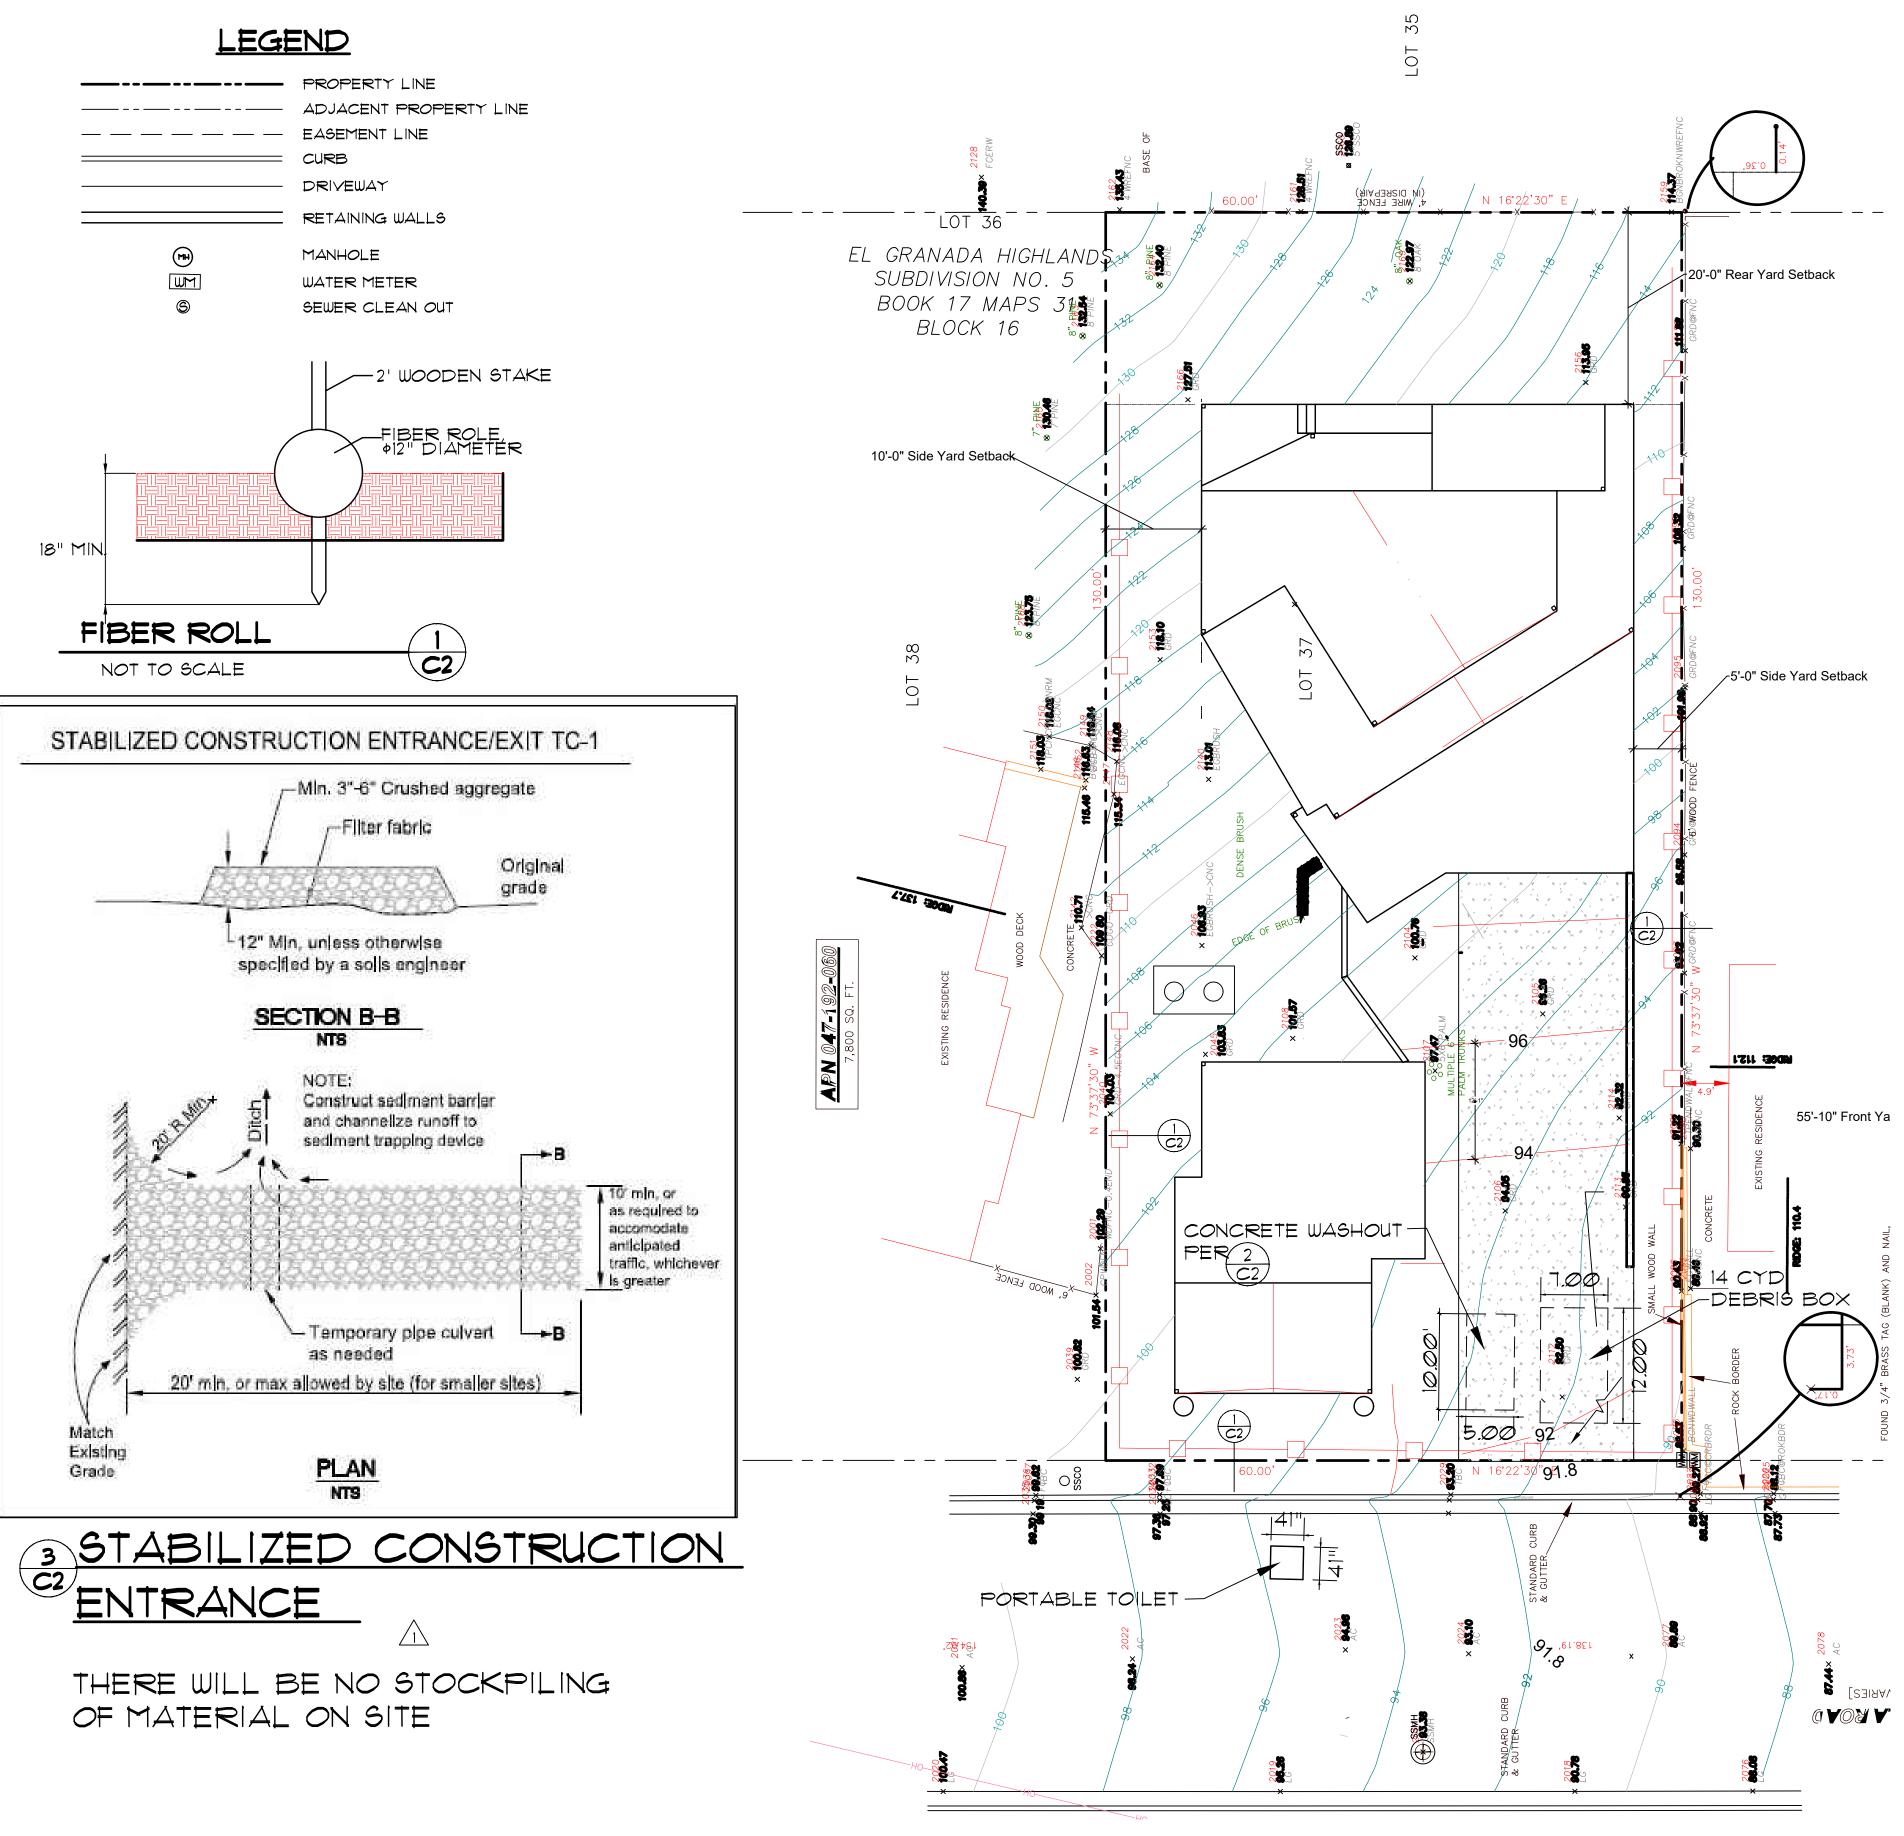



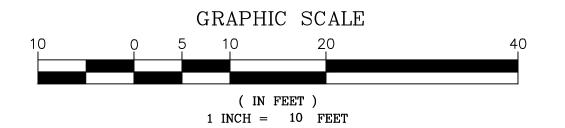

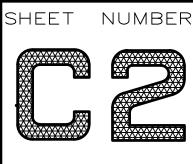

HALF

FOR ROAD,

EROSION 530 ISABI

NO.

10 NA 10 ASSOCIATES

DOMINGUEZ


REVISION


DATE


8-30-2024

OF SHEETS
DATE 1-15-24
FILE POT 2346




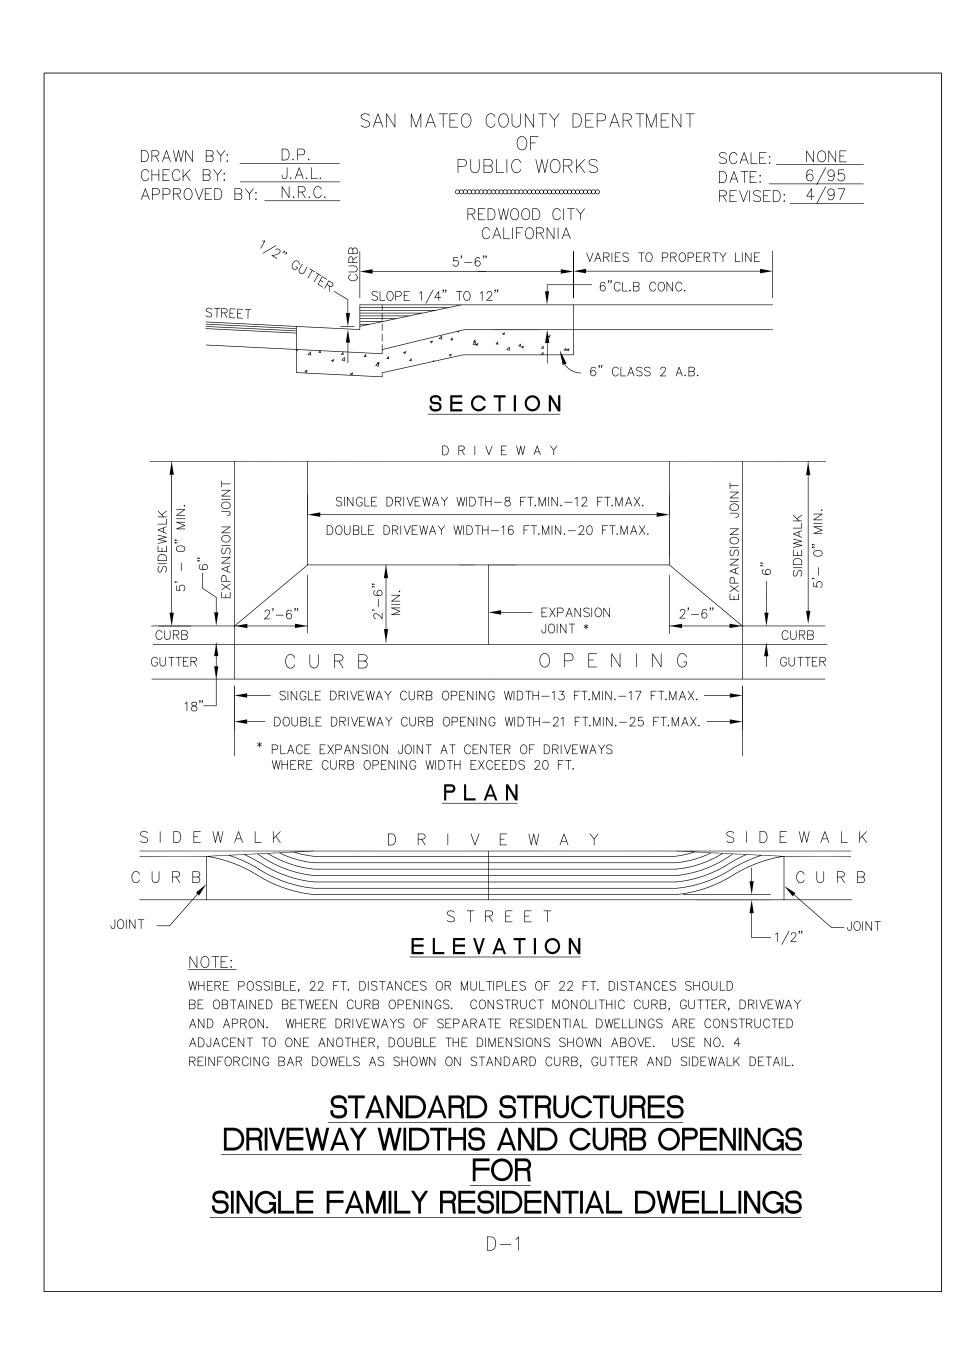

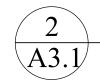

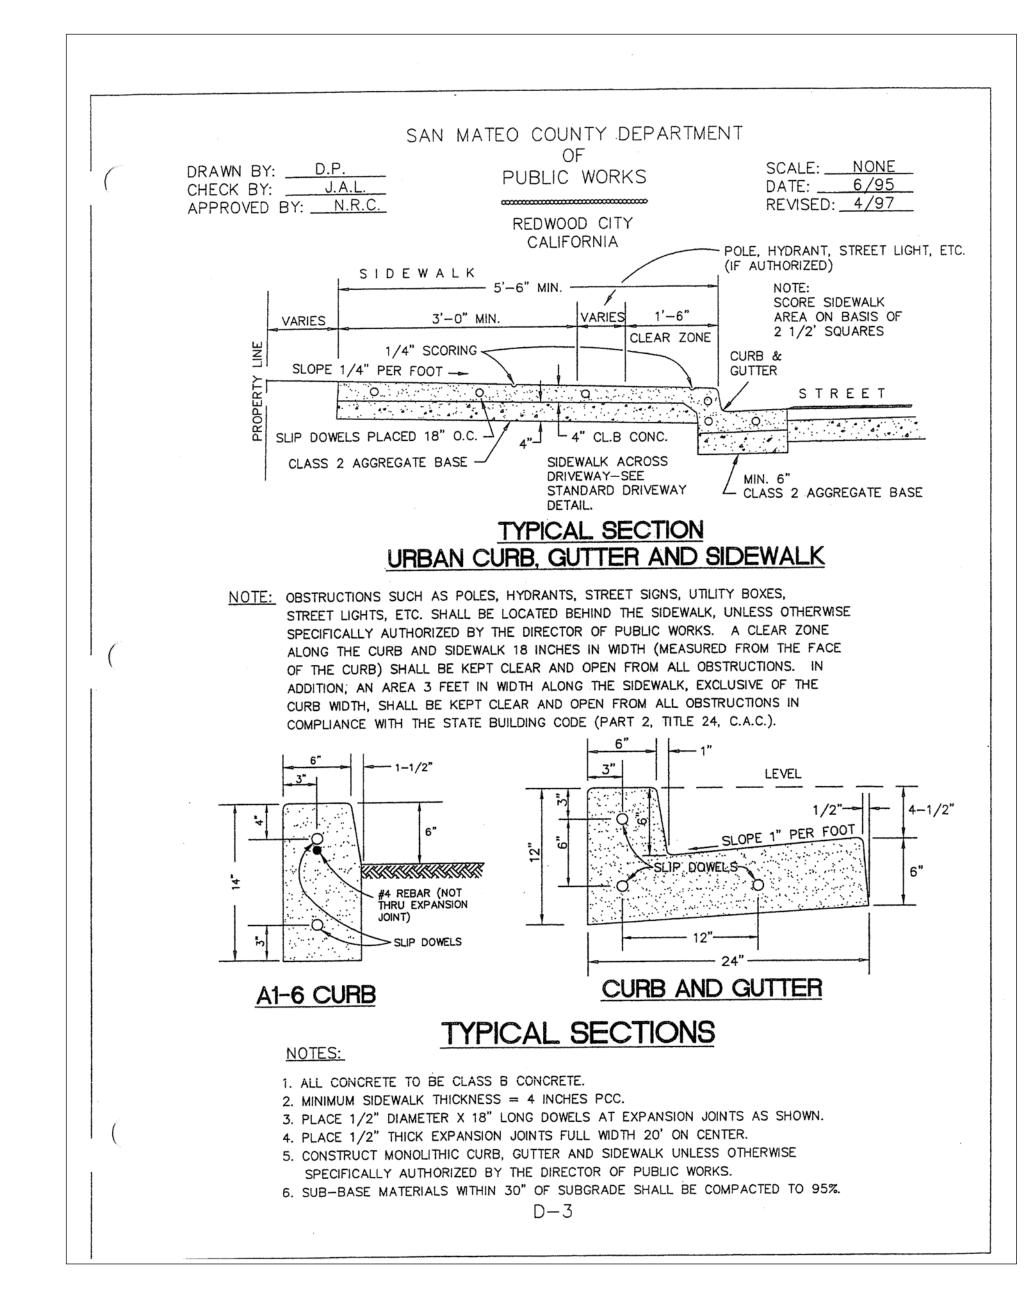

3 A3.1

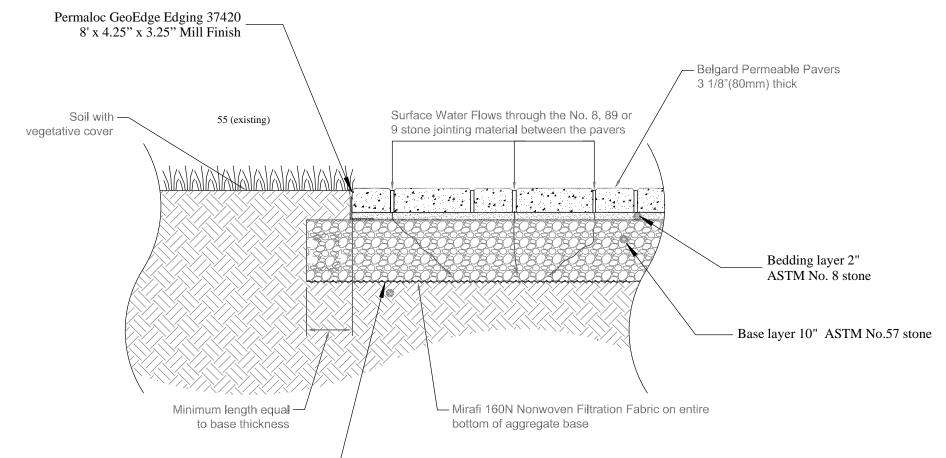

Native subgrade —

Designer: Tim Pond
Tim Pond Design and Construction
Phone 650.576.7177 timepond@gmail.com

Drawn By Tim Pond
CA Contractor's License # 931840

Drawn By TP Scale 1/4" = 1'

Revisions Date

Building submittal 6.10.21

Site Details A1.3

Alexis and Sarita

alexis_genest@yahoo. com 530 Isabella Rd, Half Moon Bay, CA

OWNER:





Belgard Aqualine Victorian




Construction Best Management Practices (BMPs)

Construction projects are required to implement the stormwater best management practices (BMP) on this page, as they apply to your project, all year long.

Clean Water. Healthy Community.

Materials & Waste Management

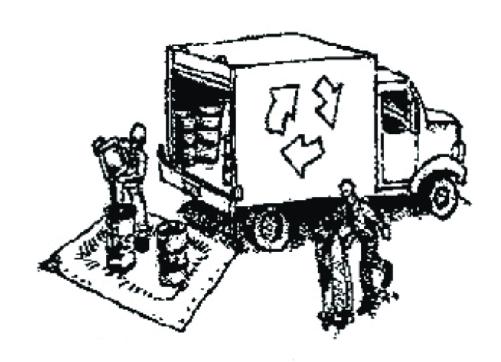

Non-Hazardous Materials

- ☐ Berm and cover stockpiles of sand, dirt or other construction material with tarps when rain is forecast or if not actively being used within 14 days.
- ☐ Use (but don't overuse) reclaimed water for dust control.

Hazardous Materials

- ☐ Label all hazardous materials and hazardous wastes (such as pesticides, paints, thinners, solvents, fuel, oil, and antifreeze) in accordance with city, county, state and federal regulations.
- ☐ Store hazardous materials and wastes in water tight containers, store in appropriate secondary containment, and cover them at the end of every work day or during wet weather or when rain is forecast.
- ☐ Follow manufacturer's application instructions for hazardous materials and be careful not to use more than necessary. Do not apply chemicals outdoors when rain is forecast within 24 hours.
- ☐ Arrange for appropriate disposal of all hazardous wastes.

Waste Management

- ☐ Cover waste disposal containers securely with tarps at the end of every work day and during wet weather.
- ☐ Check waste disposal containers frequently for leaks and to make sure they are not overfilled. Never hose down a dumpster on the construction site.
- ☐ Clean or replace portable toilets, and inspect them frequently for leaks and spills.
- ☐ Dispose of all wastes and debris properly. Recycle materials and wastes that can be recycled (such as asphalt, concrete, aggregate base materials, wood, gyp board, pipe, etc.)
- ☐ Dispose of liquid residues from paints, thinners, solvents, glues, and cleaning fluids as hazardous waste.

Construction Entrances and Perimeter

- ☐ Establish and maintain effective perimeter controls and stabilize all construction entrances and exits to sufficiently control erosion and sediment discharges from site and tracking off site.
- ☐ Sweep or vacuum any street tracking immediately and secure sediment source to prevent further tracking. Never hose down streets to clean up tracking.

Equipment Management & Spill Control




Maintenance and Parking

- ☐ Designate an area, fitted with appropriate BMPs, for vehicle and equipment parking and storage.
- ☐ Perform major maintenance, repair jobs, and vehicle and equipment washing off site.
- ☐ If refueling or vehicle maintenance must be done onsite, work in a bermed area away from storm drains and over a drip pan or drop cloths big enough to collect fluids. Recycle or dispose of fluids as hazardous waste.
- ☐ If vehicle or equipment cleaning must be done onsite, clean with water only in a bermed area that will not allow rinse water to run into gutters, streets, storm drains, or surface waters.
- Do not clean vehicle or equipment onsite using soaps, solvents, degreasers, or steam cleaning equipment.

Spill Prevention and Control

- ☐ Keep spill cleanup materials (e.g., rags, absorbents and cat litter) available at the construction site at all times.
- ☐ Inspect vehicles and equipment frequently for and repair leaks promptly. Use drip pans to catch leaks until repairs are made.
- ☐ Clean up spills or leaks immediately and dispose of cleanup materials properly.
- ☐ Do not hose down surfaces where fluids have spilled. Use dry cleanup methods (absorbent materials, cat litter, and/or rags).
- ☐ Sweep up spilled dry materials immediately. Do not try to wash them away with water, or bury them.
- ☐ Clean up spills on dirt areas by digging up and properly disposing of contaminated soil.
- ☐ Report significant spills immediately. You are required by law to report all significant releases of hazardous materials, including oil. To report a spill: 1) Dial 911 or your local emergency response number, 2) Call the Governor's Office of Emergency Services Warning Center, (800) 852-7550 (24 hours).

Earthmoving

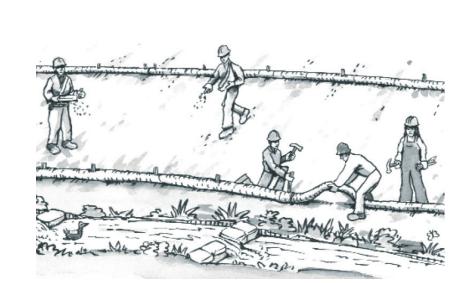

- ☐ Schedule grading and excavation work during dry weather.
- ☐ Stabilize all denuded areas, install and maintain temporary erosion controls (such as erosion control fabric or bonded fiber matrix) until vegetation is established.
- ☐ Remove existing vegetation only when absolutely necessary, and seed or plant vegetation for erosion control on slopes or where construction is not immediately
- ☐ Prevent sediment from migrating offsite and protect storm drain inlets, gutters, ditches, and drainage courses by installing and maintaining appropriate BMPs, such as fiber rolls, silt fences, sediment basins, gravel bags, berms, etc.
- ☐ Keep excavated soil on site and transfer it to dump trucks on site, not in the streets.

Contaminated Soils

- ☐ If any of the following conditions are observed, test for contamination and contact the Regional Water Quality Control Board:
- Unusual soil conditions, discoloration, or odor.
- Abandoned underground tanks.
- Abandoned wells
- Buried barrels, debris, or trash

Paving/Asphalt Work



- ☐ Avoid paving and seal coating in wet weather or when rain is forecast, to prevent materials that have not cured from contacting stormwater runoff.
- ☐ Cover storm drain inlets and manholes when applying seal coat, tack coat, slurry seal, fog seal, etc.
- ☐ Collect and recycle or appropriately dispose of excess abrasive gravel or sand. Do NOT sweep or wash it into gutters.
- ☐ Do not use water to wash down fresh asphalt concrete pavement.


Sawcutting & Asphalt/Concrete Removal

- ☐ Protect nearby storm drain inlets when saw cutting. Use filter fabric, catch basin inlet filters, or gravel bags to keep slurry out of the storm drain system.
- ☐ Shovel, abosorb, or vacuum saw-cut slurry and dispose of all waste as soon as you are finished in one location or at the end of each work day (whichever is sooner!).
- ☐ If sawcut slurry enters a catch basin, clean it up immediately.

Concrete, Grout & Mortar




- ☐ Store concrete, grout, and mortar away from storm drains or waterways, and on pallets under cover to protect them from rain, runoff, and wind.
- ☐ Wash out concrete equipment/trucks offsite or in a designated washout area, where the water will flow into a temporary waste pit, and in a manner that will prevent leaching into the underlying soil or onto surrounding areas. Let concrete harden and dispose of as garbage.
- ☐ When washing exposed aggregate, prevent washwater from entering storm drains. Block any inlets and vacuum gutters, hose washwater onto dirt areas, or drain onto a bermed surface to be pumped and disposed of properly.

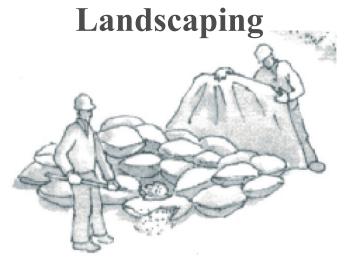

- ☐ Protect stockpiled landscaping materials from wind and rain by storing them under tarps all year-round.
- ☐ Stack bagged material on pallets and under cover.
- ☐ Discontinue application of any erodible landscape material within 2 days before a forecast rain event or during wet weather.


Painting & Paint Removal

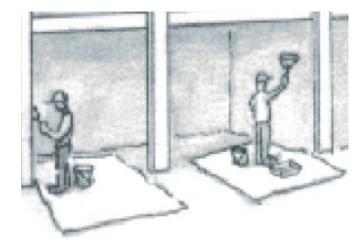

Painting Cleanup and Removal


- ☐ Never clean brushes or rinse paint containers into a street, gutter, storm drain, or stream.
- ☐ For water-based paints, paint out brushes to the extent possible, and rinse into a drain that goes to the sanitary sewer. Never pour paint down a storm drain.
- ☐ For oil-based paints, paint out brushes to the extent possible and clean with thinner or solvent in a proper container. Filter and reuse thinners and solvents. Dispose of excess liquids as hazardous waste.
- ☐ Paint chips and dust from non-hazardous dry stripping and sand blasting may be swept up or collected in plastic drop cloths and disposed of as trash.
- ☐ Chemical paint stripping residue and chips and dust from marine paints or paints containing lead, mercury, or tributyltin must be disposed of as hazardous waste. Lead based paint removal requires a statecertified contractor.

Dewatering

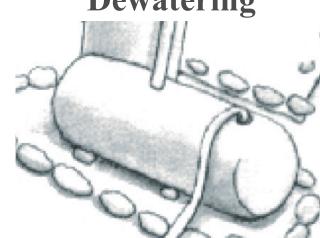



- ☐ Discharges of groundwater or captured runoff from dewatering operations must be properly managed and disposed. When possible send dewatering discharge to landscaped area or sanitary sewer. If discharging to the sanitary sewer call your local wastewater treatment plant.
- ☐ Divert run-on water from offsite away from all disturbed areas.
- ☐ When dewatering, notify and obtain approval from the local municipality before discharging water to a street gutter or storm drain. Filtration or diversion through a basin, tank, or sediment trap may be required.
- ☐ In areas of known or suspected contamination, call your local agency to determine whether the ground water must be tested. Pumped groundwater may need to be collected and hauled off-site for treatment and proper disposal.


Storm Drain Polluter May be fined up to \$10,000 per day

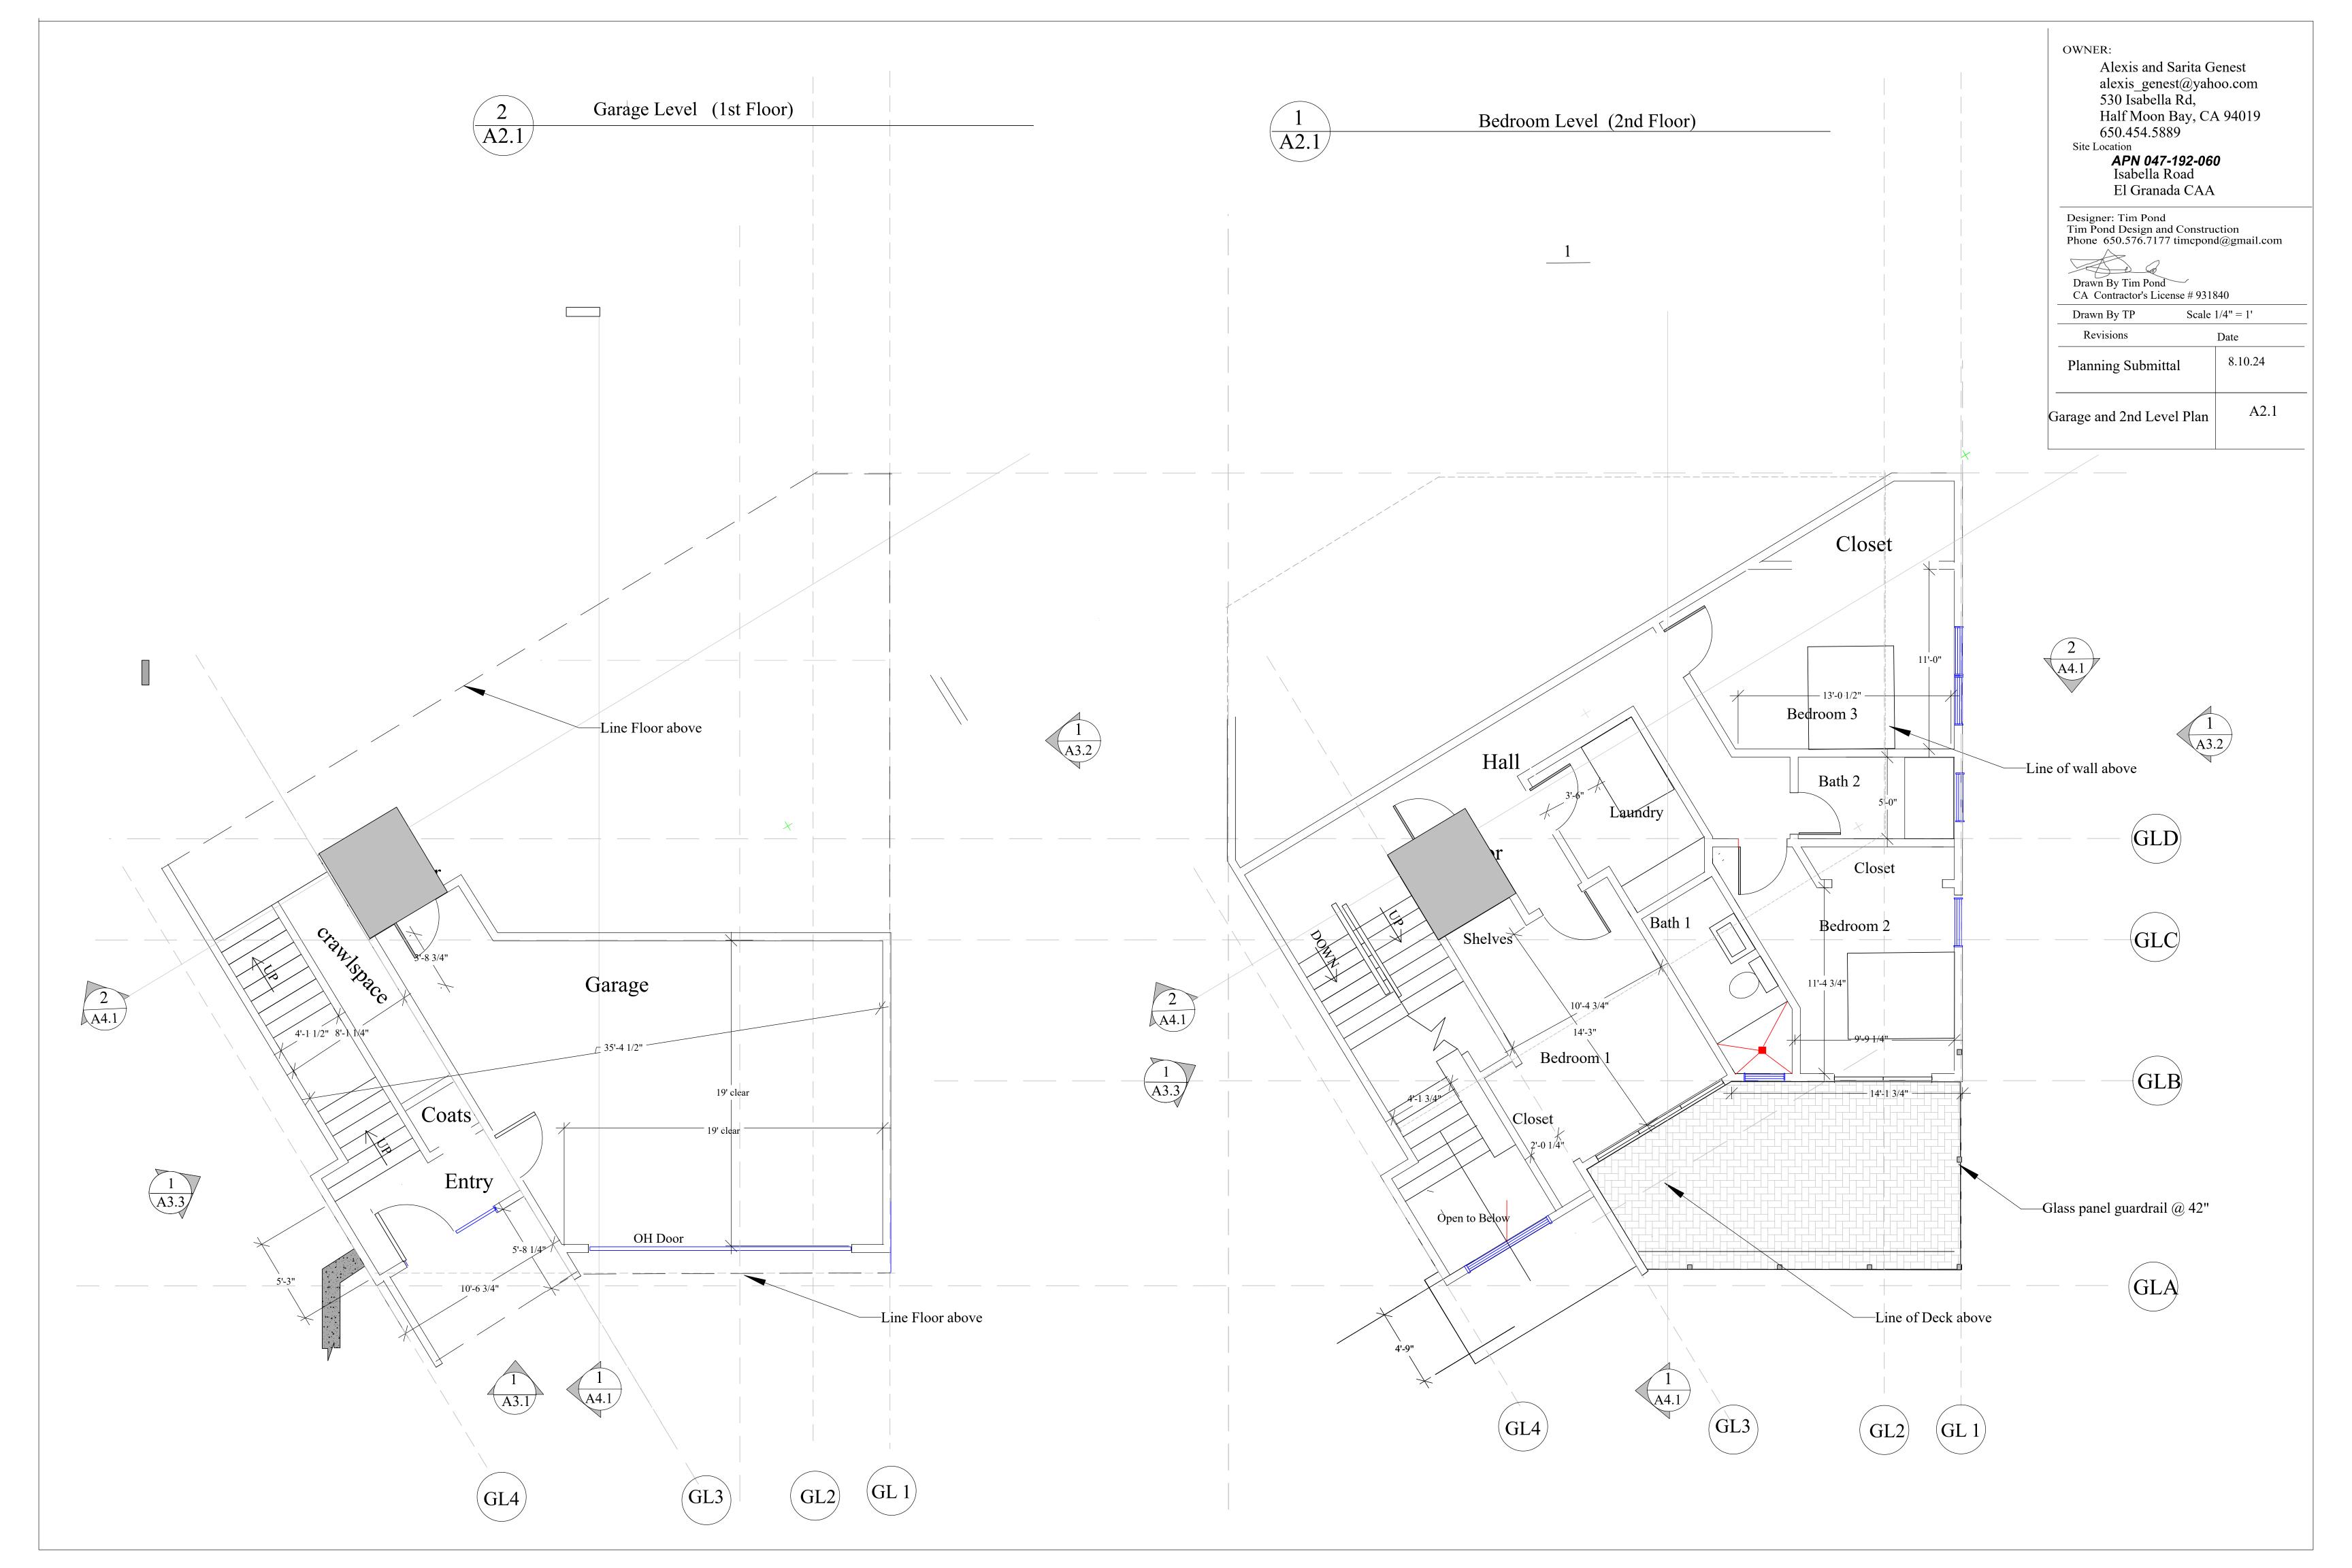



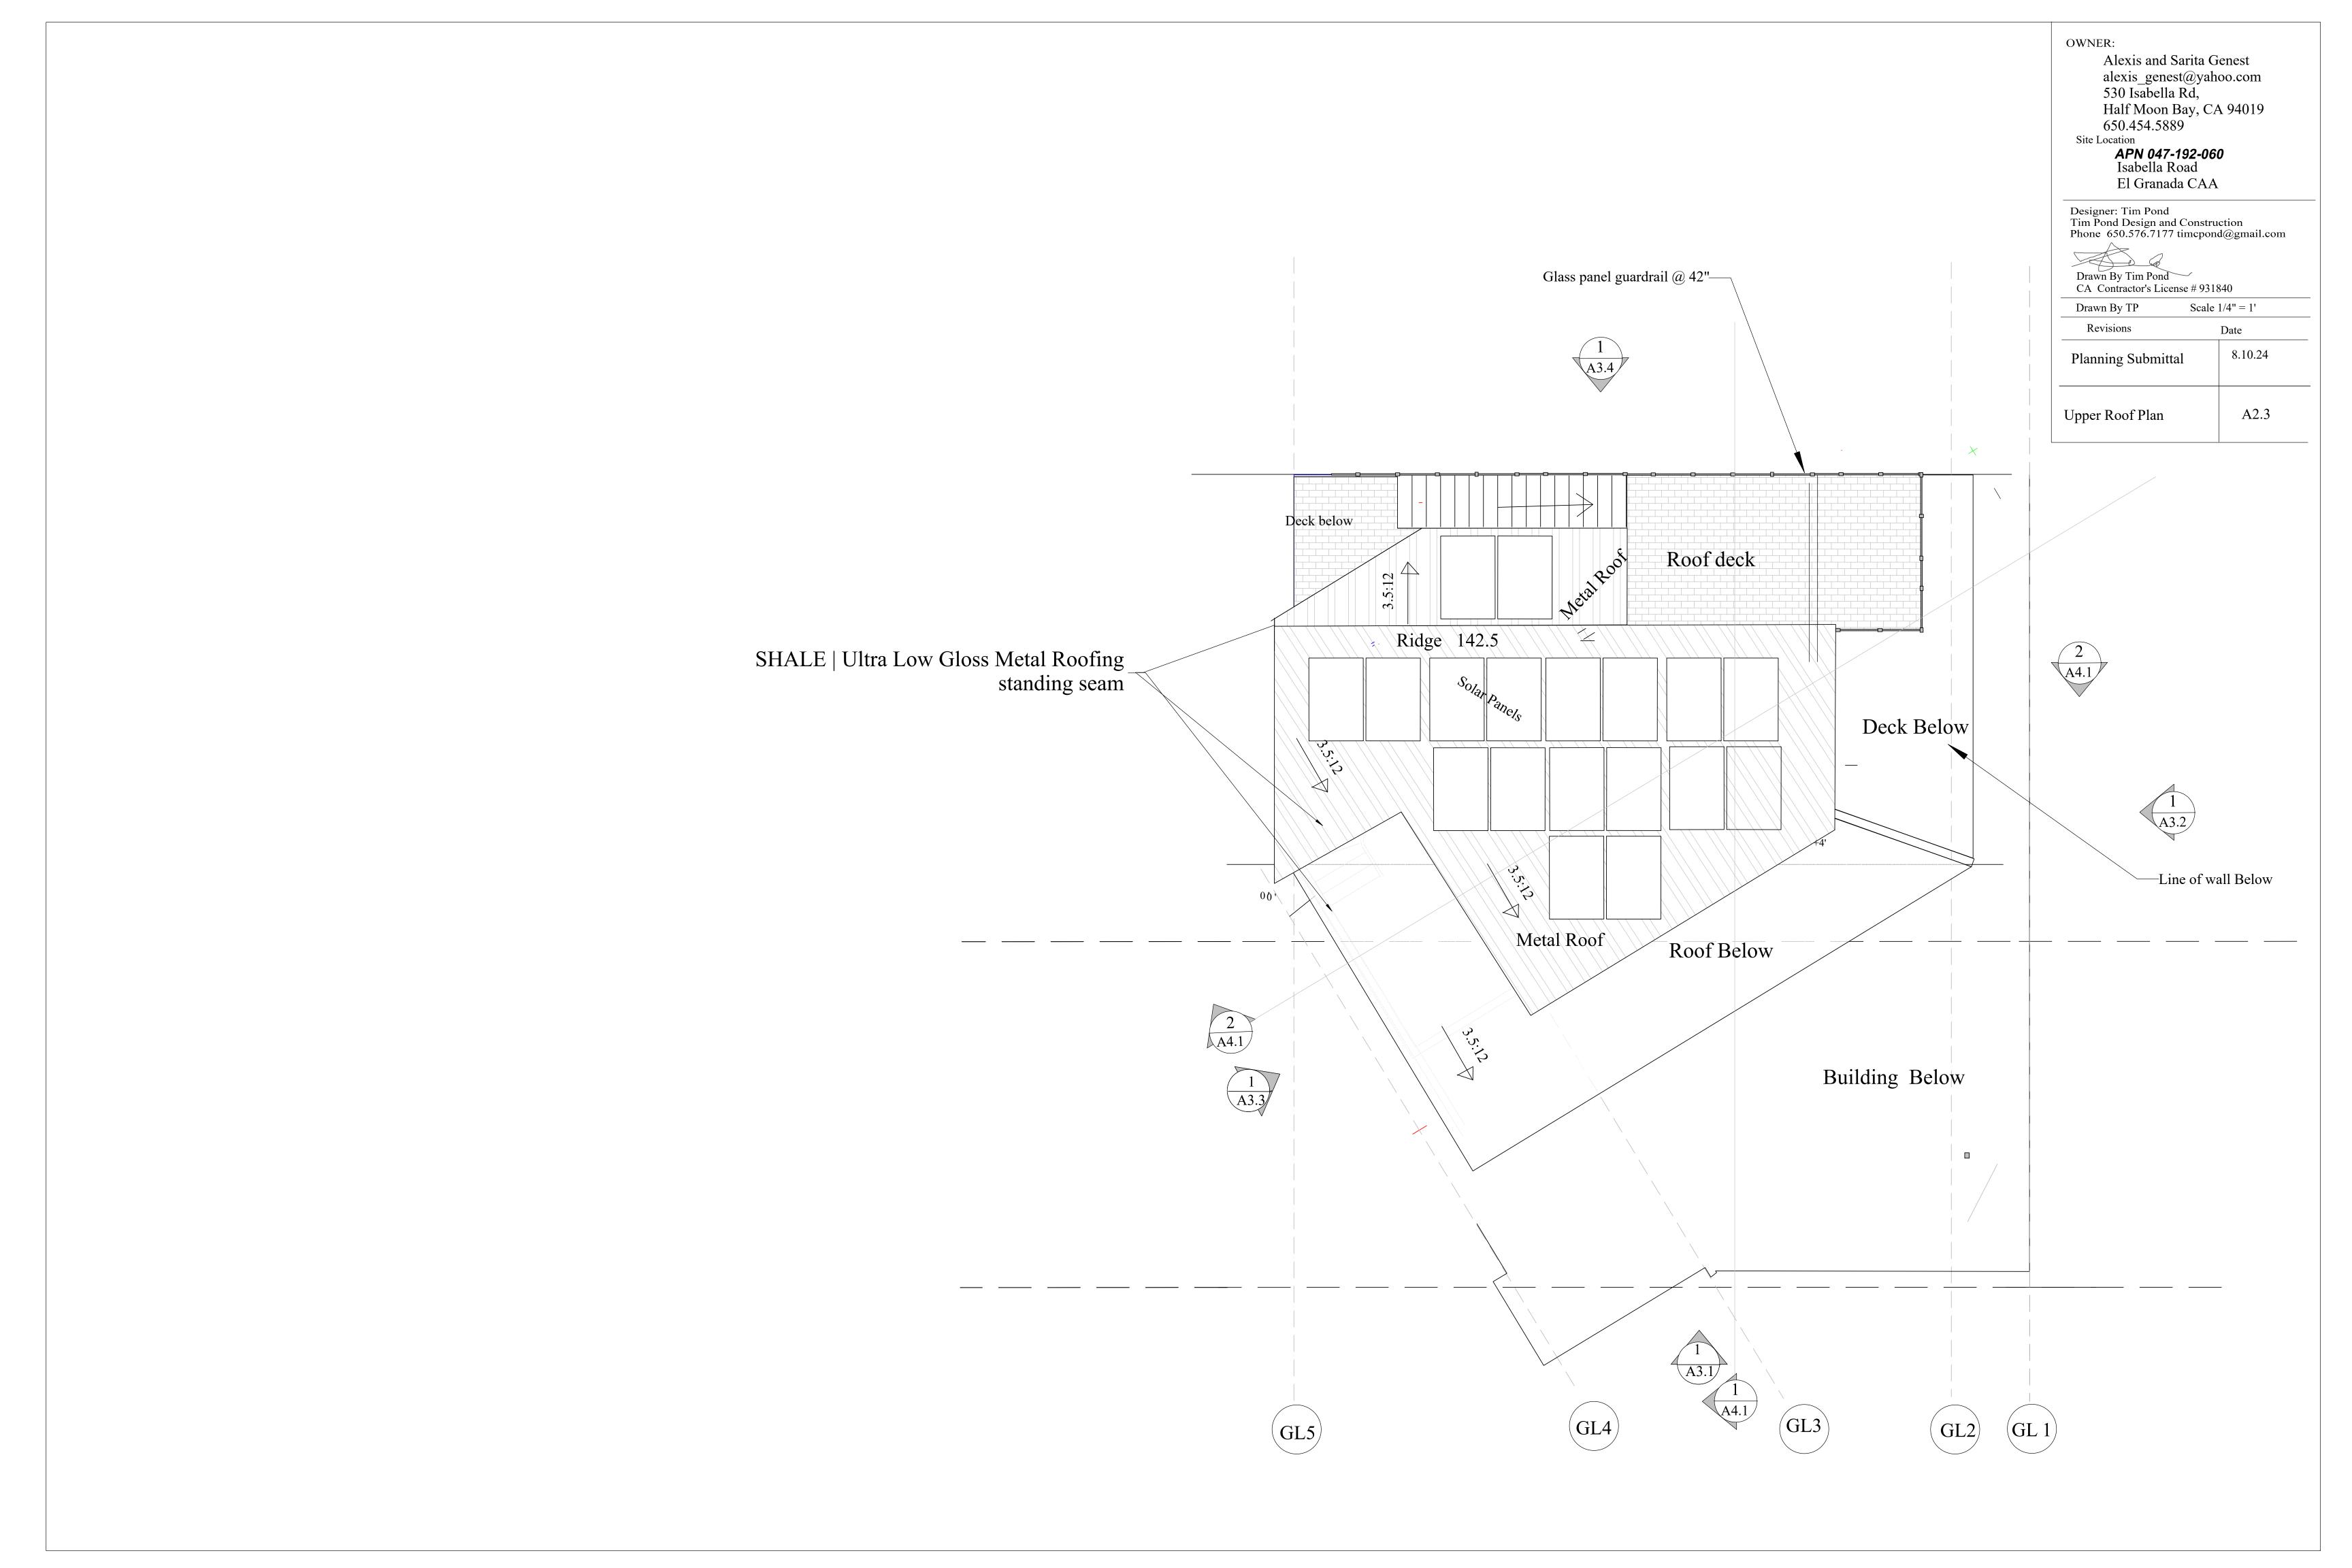

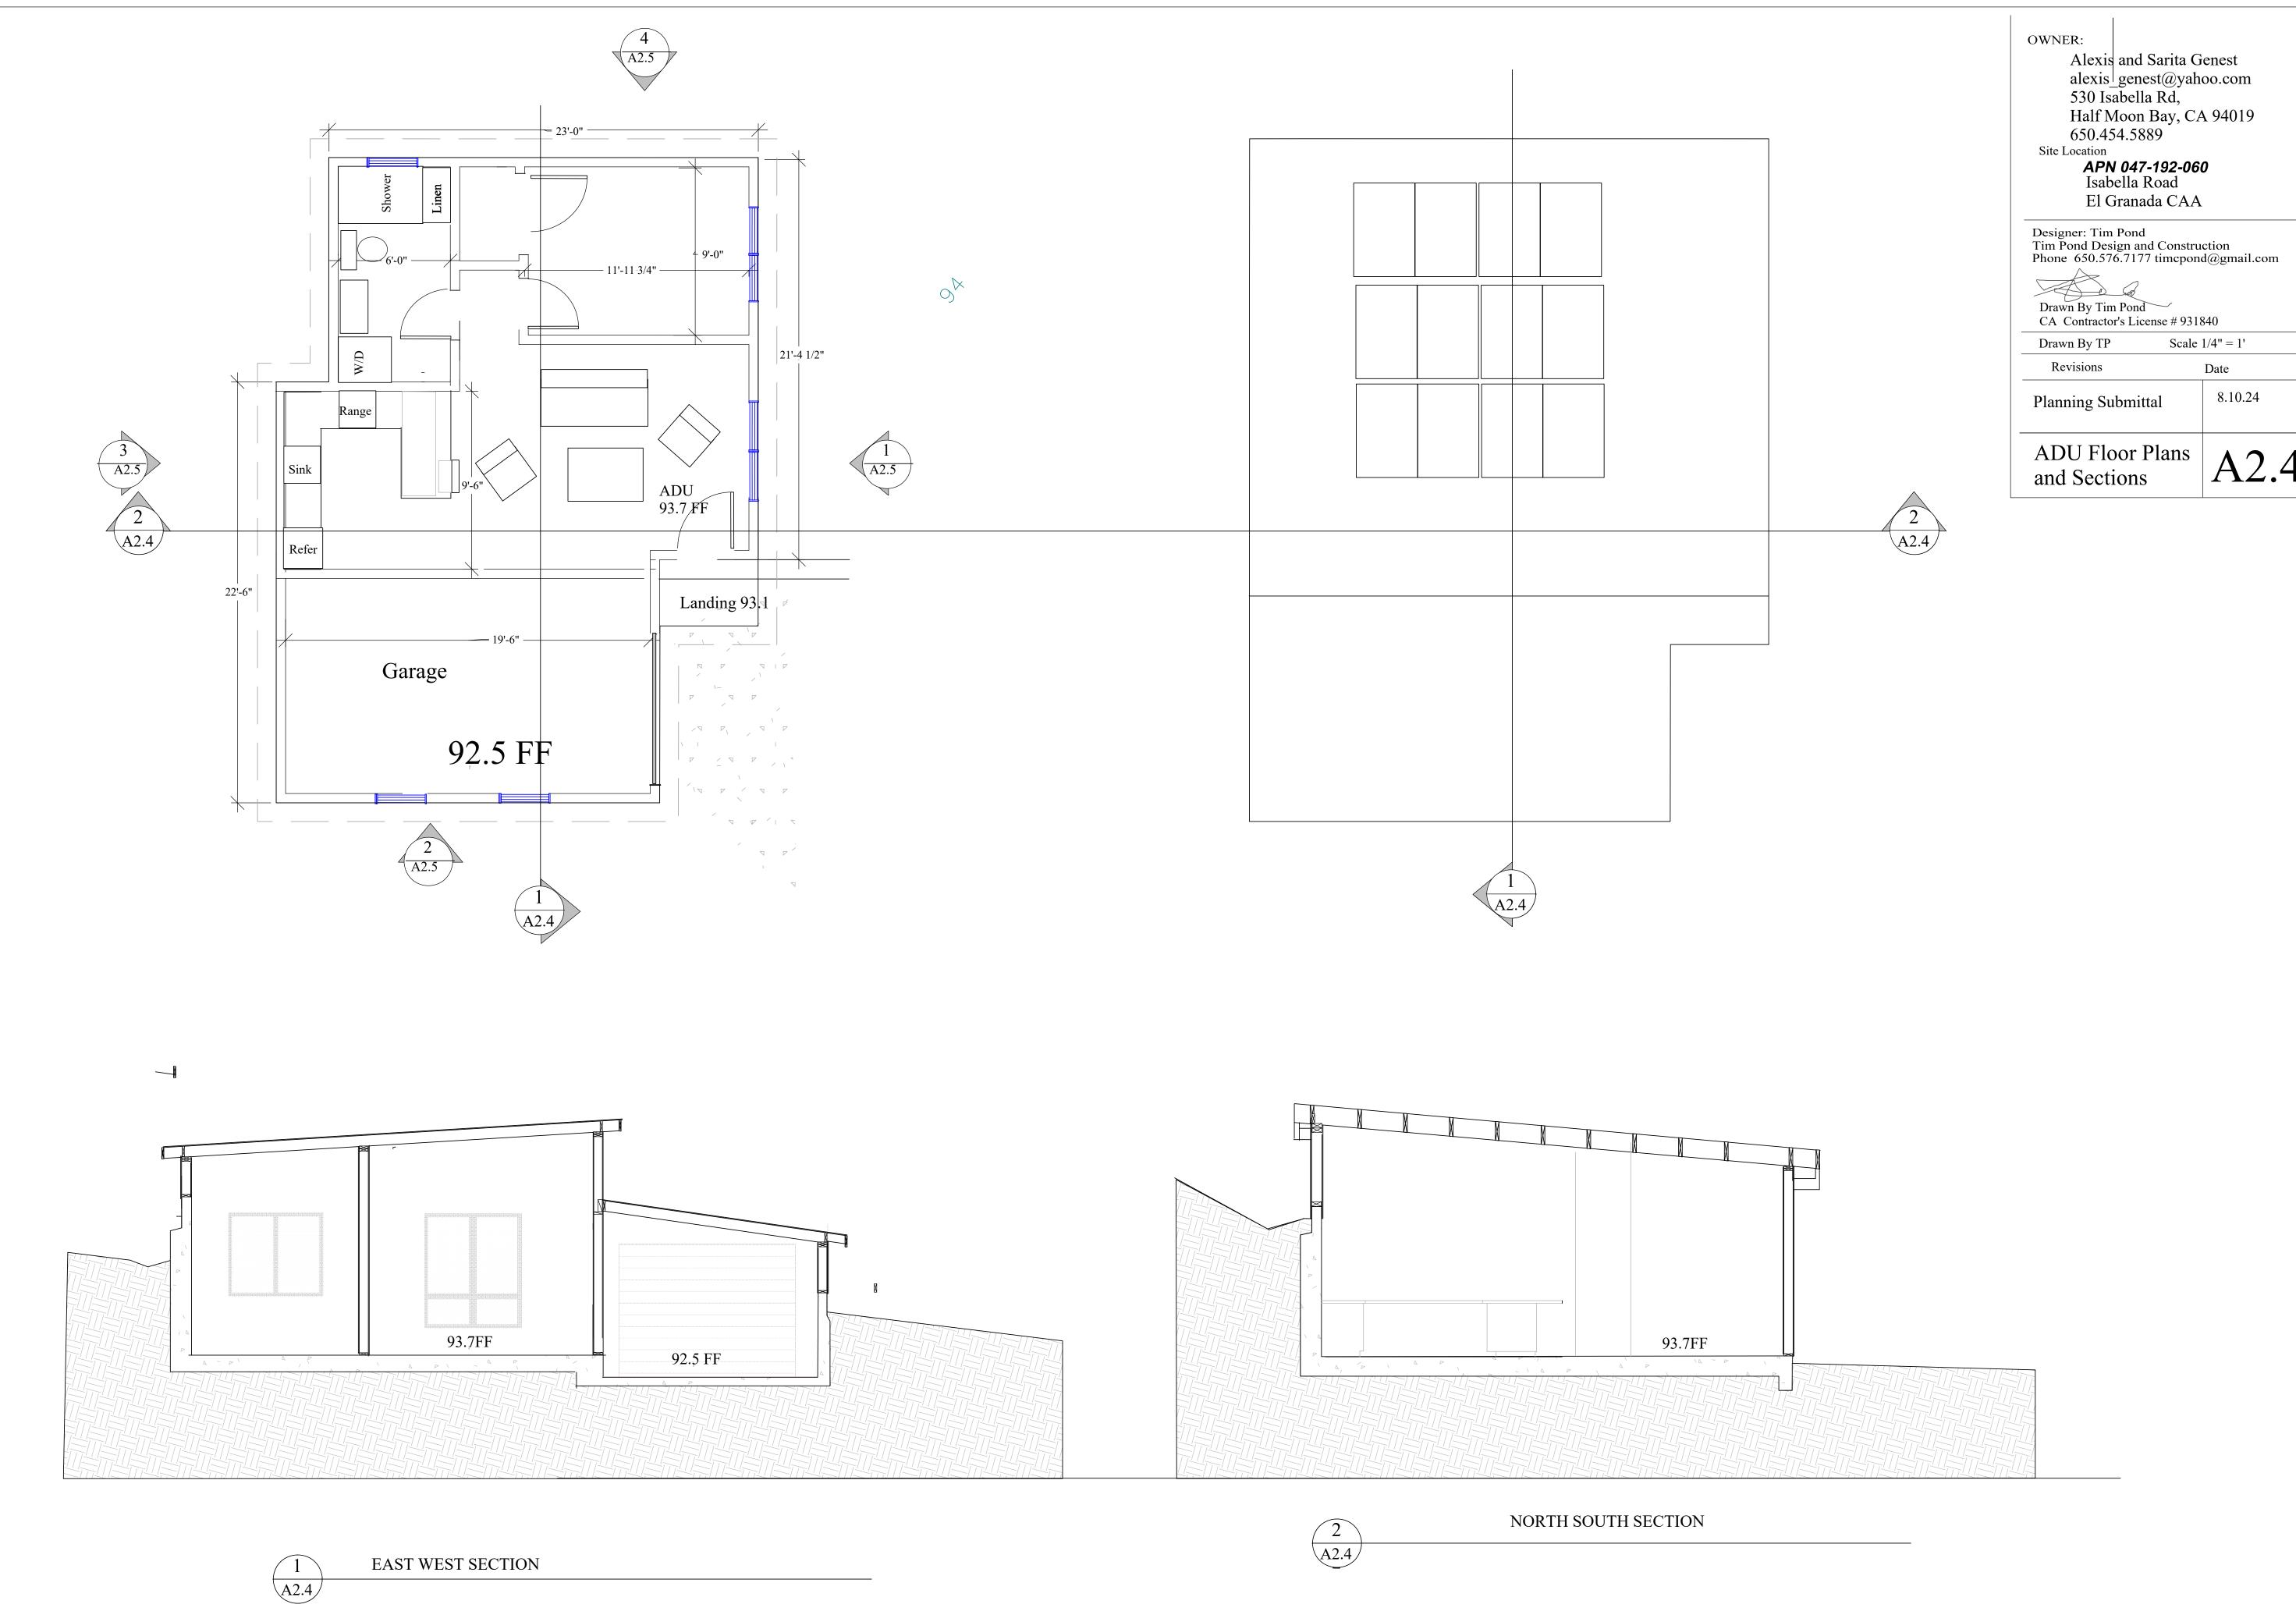

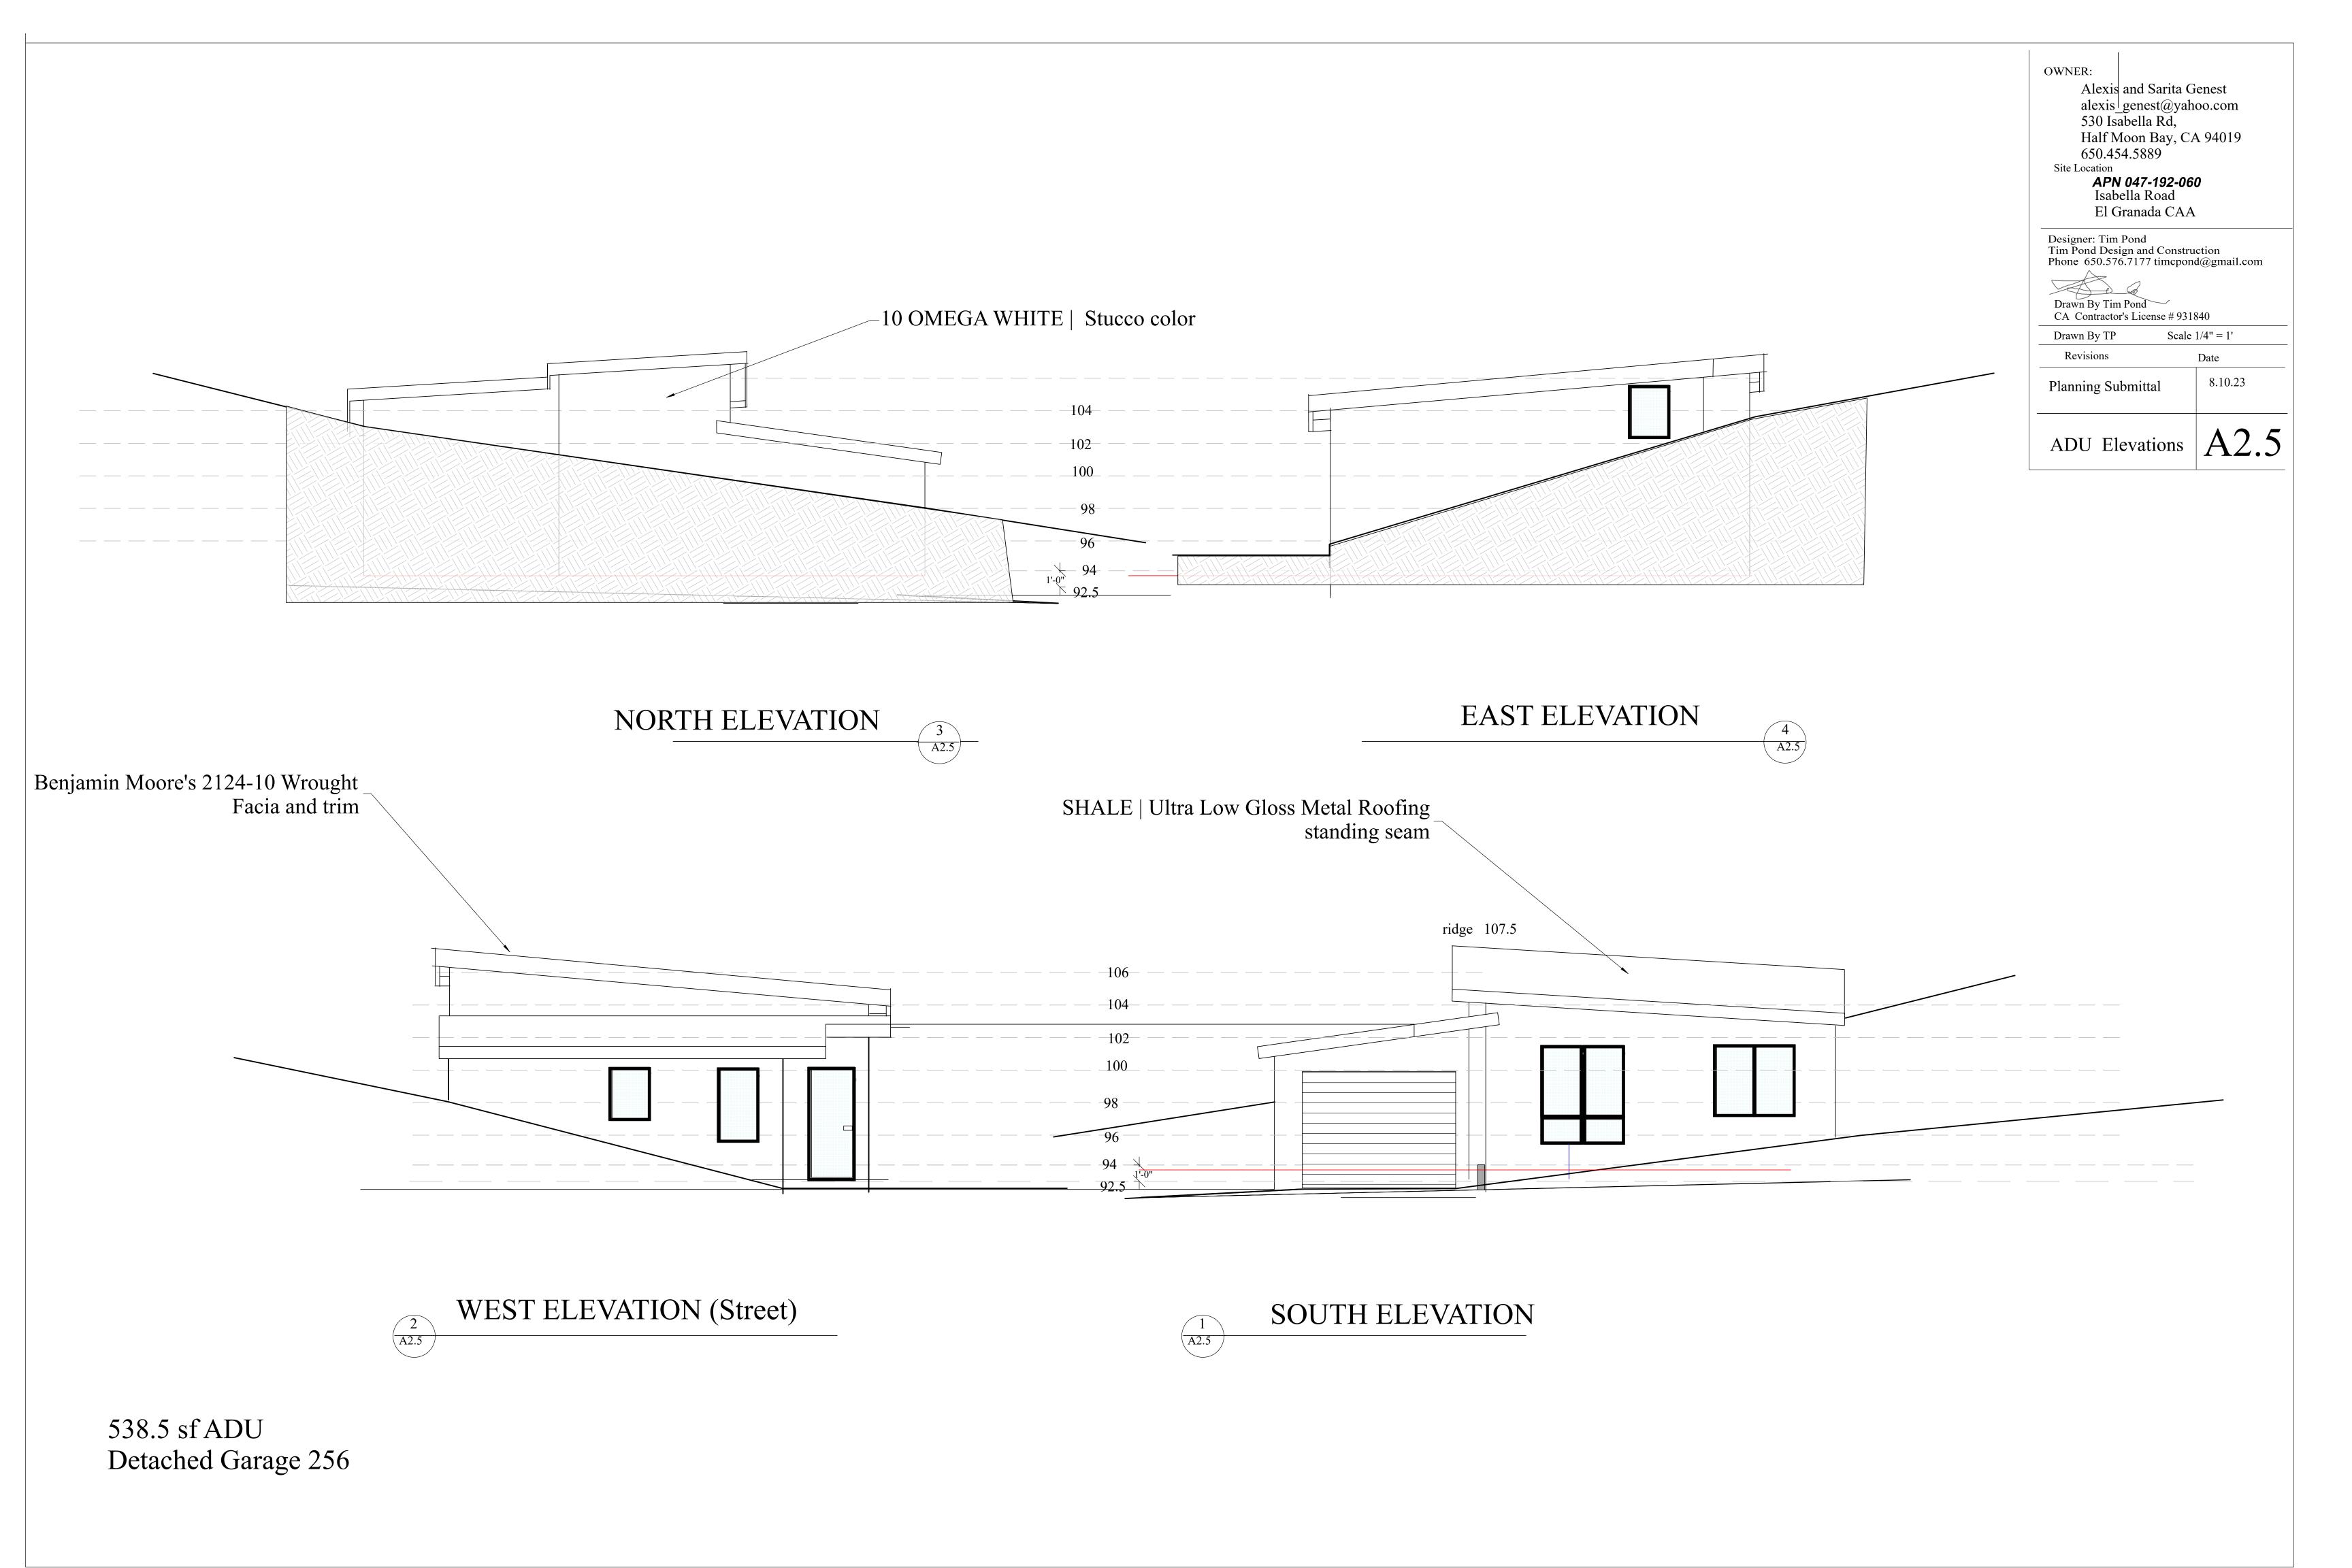



SHALE | Ultra Low Gloss Metal Roofing standing seam

Benjamin Moore's 2124-10 Wrought Facia and trim

141 Ridge

FG 105.00

Anderson 400 serieis Dark bronze frame

rson 400 series Dark bronze frame

West Elevation and Colored Perspective Drawing

A3.1

10 OMEGA WHITE Stucco color

OWNER:

Site Location

Drawn By TP

Revisions

Planning Submittal

Alexis and Sarita Genest

alexis_genest@yahoo.com 530 Isabella Rd,

Half Moon Bay, CA 94019 650.454.5889

APN 047-192-060 Isabella Road

Designer: Tim Pond Tim Pond Design and Construction Phone 650.576.7177 timcpond@gmail.com

Scale 1/4'' = 1'

7.1.23

El Granada CAA


Drawn By Tim Pond CA Contractor's License # 931840

Finish and Existing
Grade 98.00

Golden Honey Ledger Panel
Natural Quartzite Wall Tile


COLORED PERSPECTIVE DRAWING

WEST ELEVATION

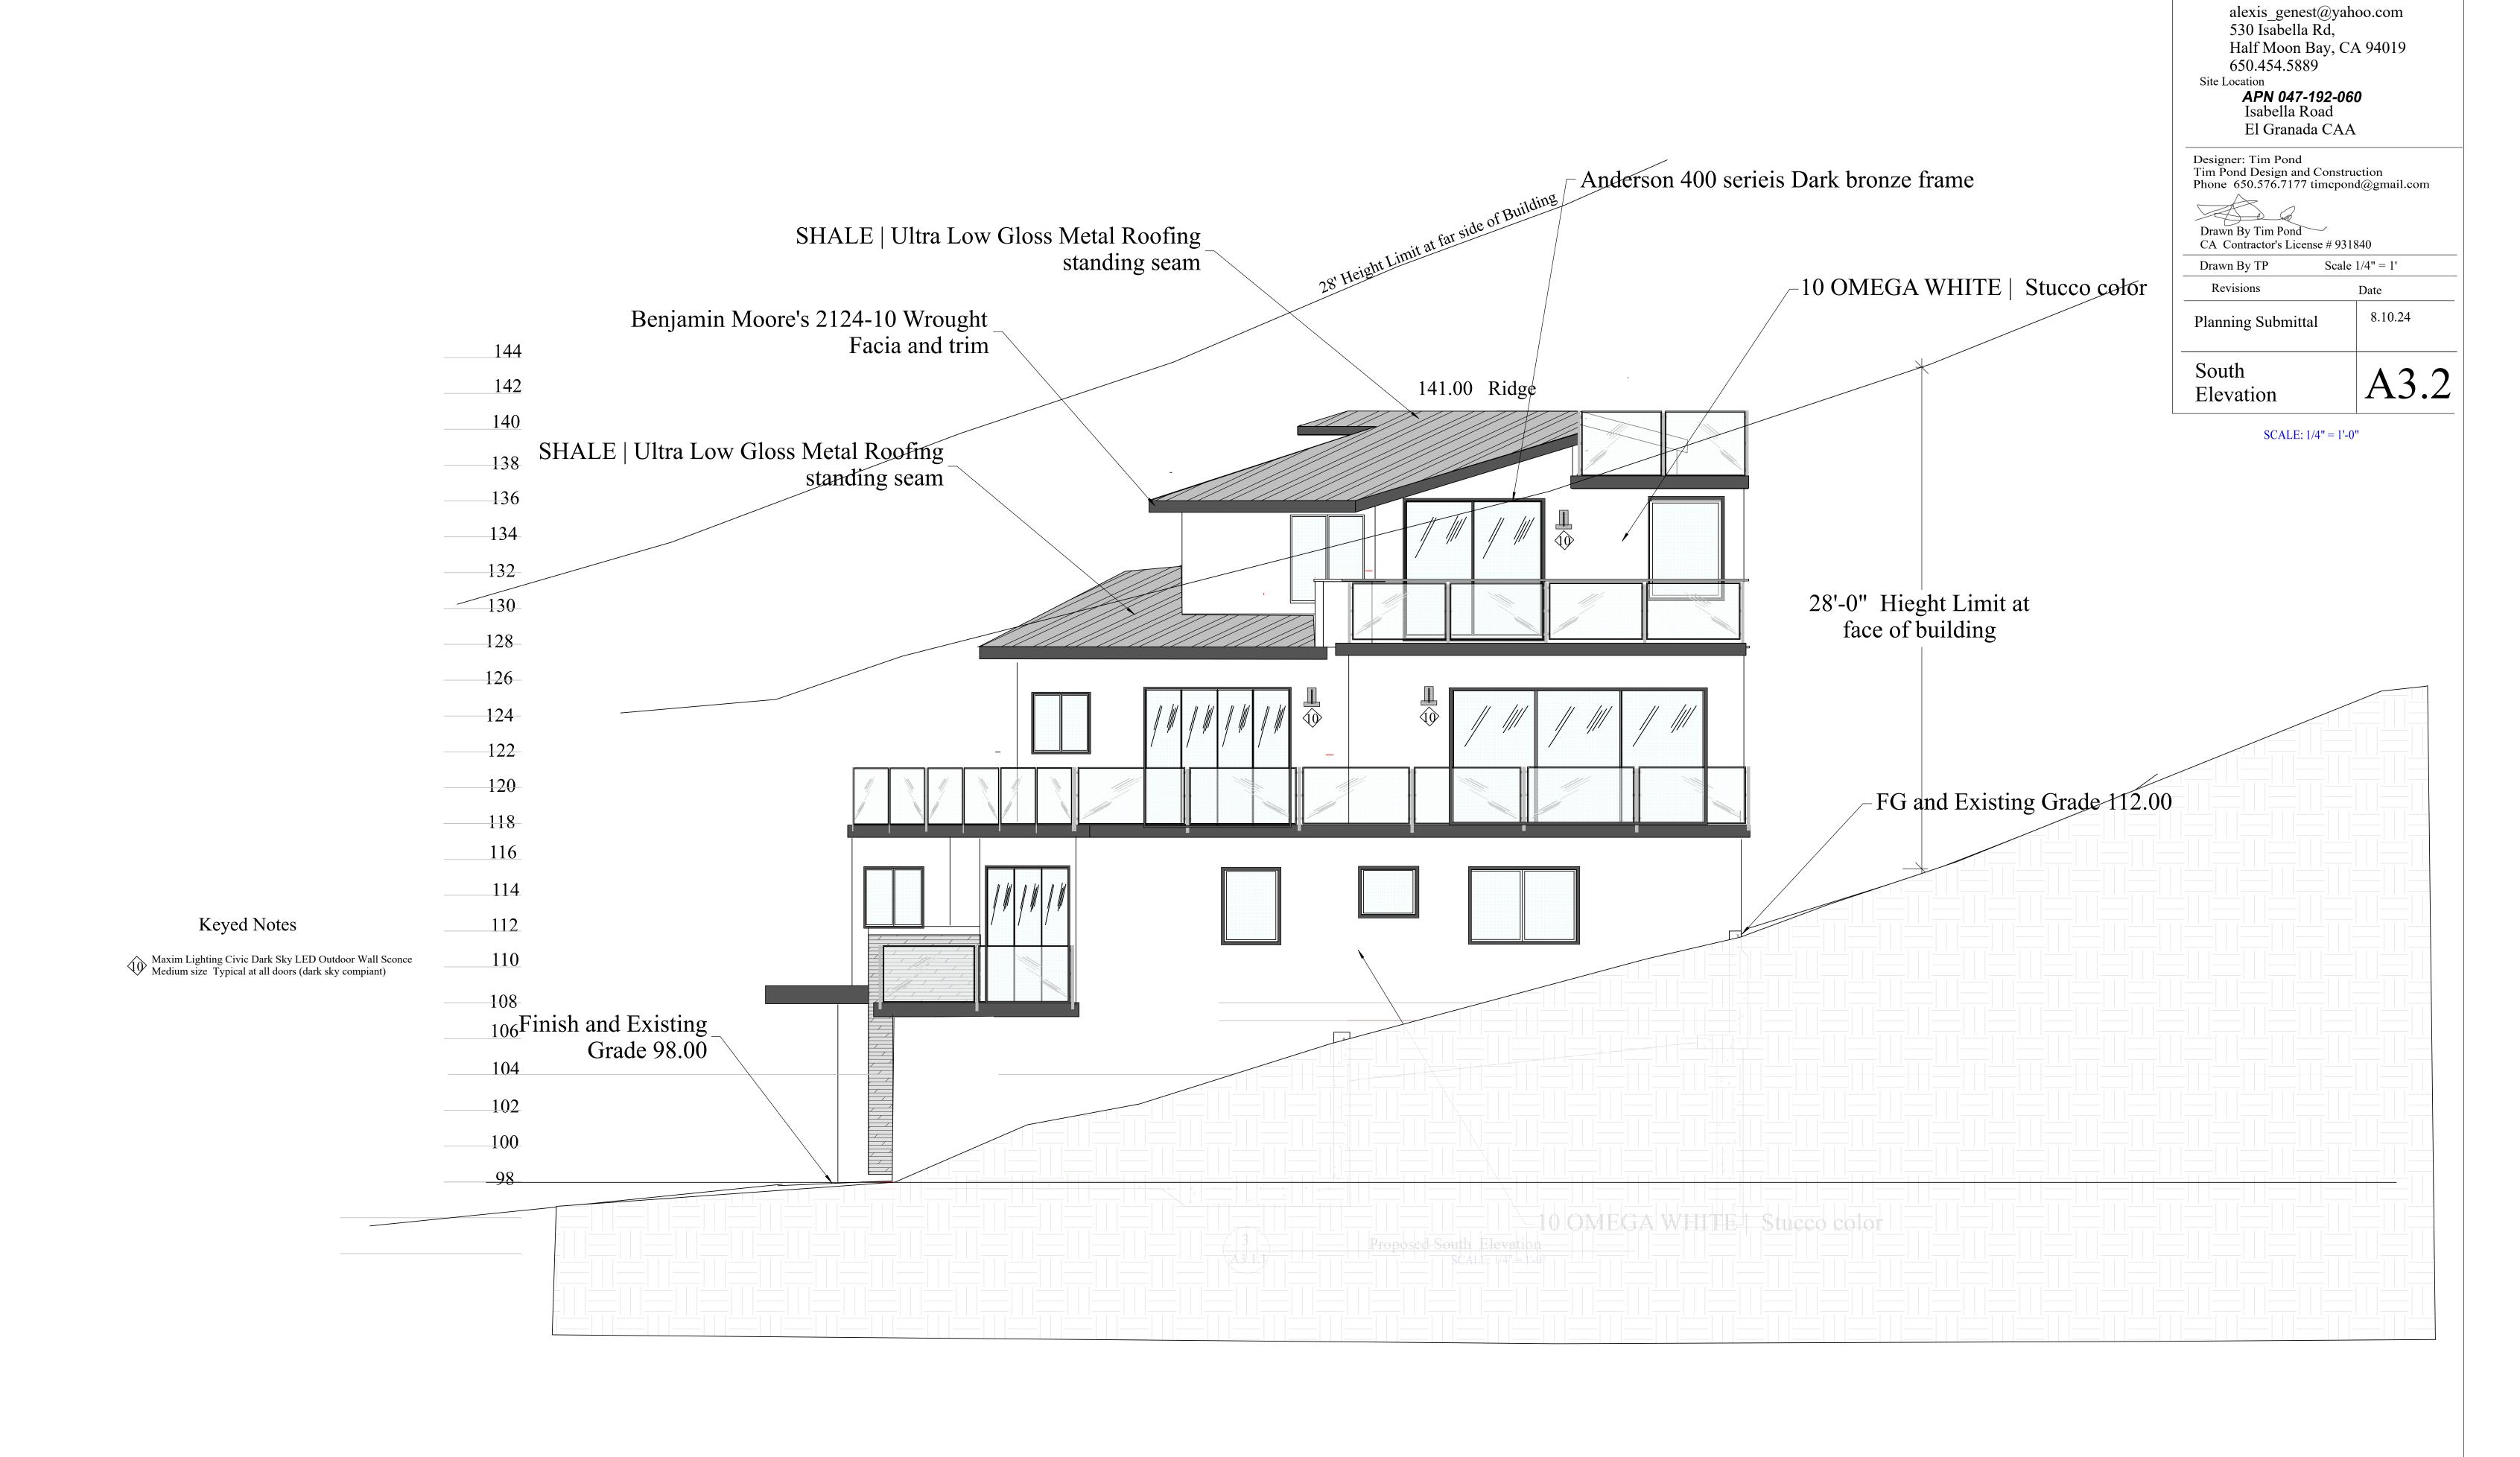

OWNER:

Alexis and Sarita Genest

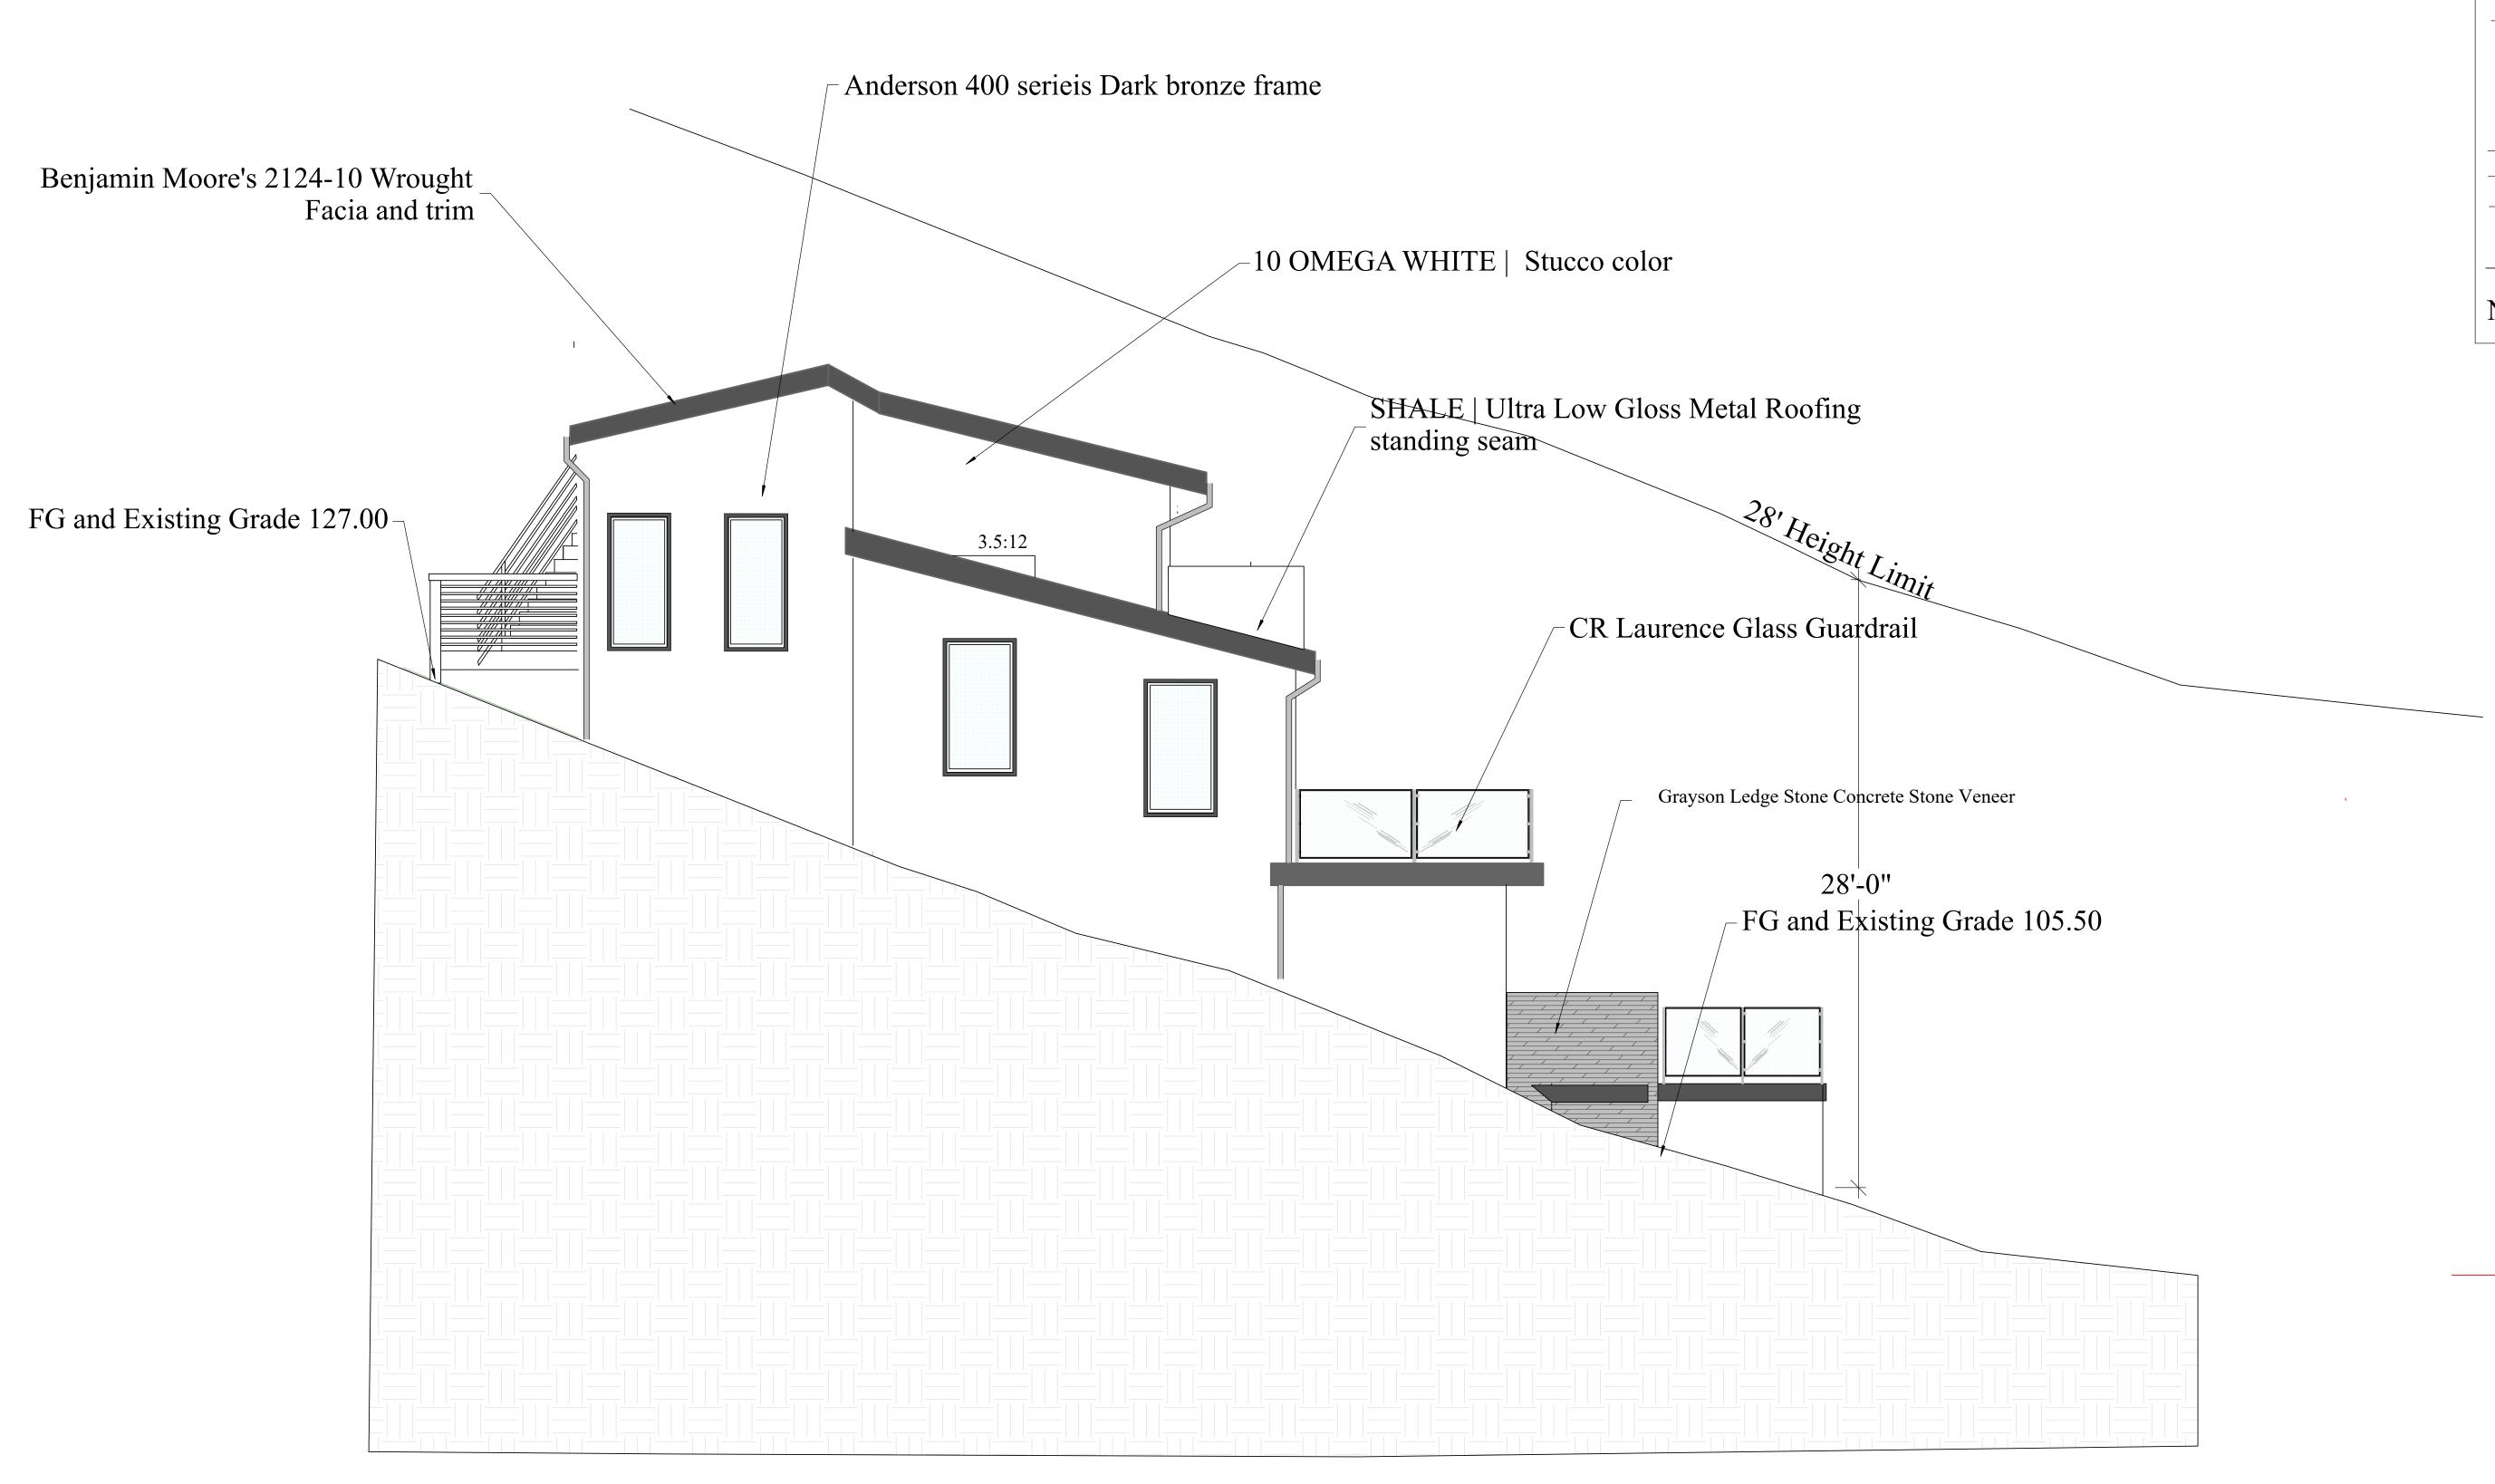

North Elevation

A3.3

Alexis and Sarita Genest alexis_genest@yahoo.com
530 Isabella Rd,
Half Moon Bay, CA 94019
650.454.5889
Site Location **APN 047-192-060** Isabella Road

OWNER:

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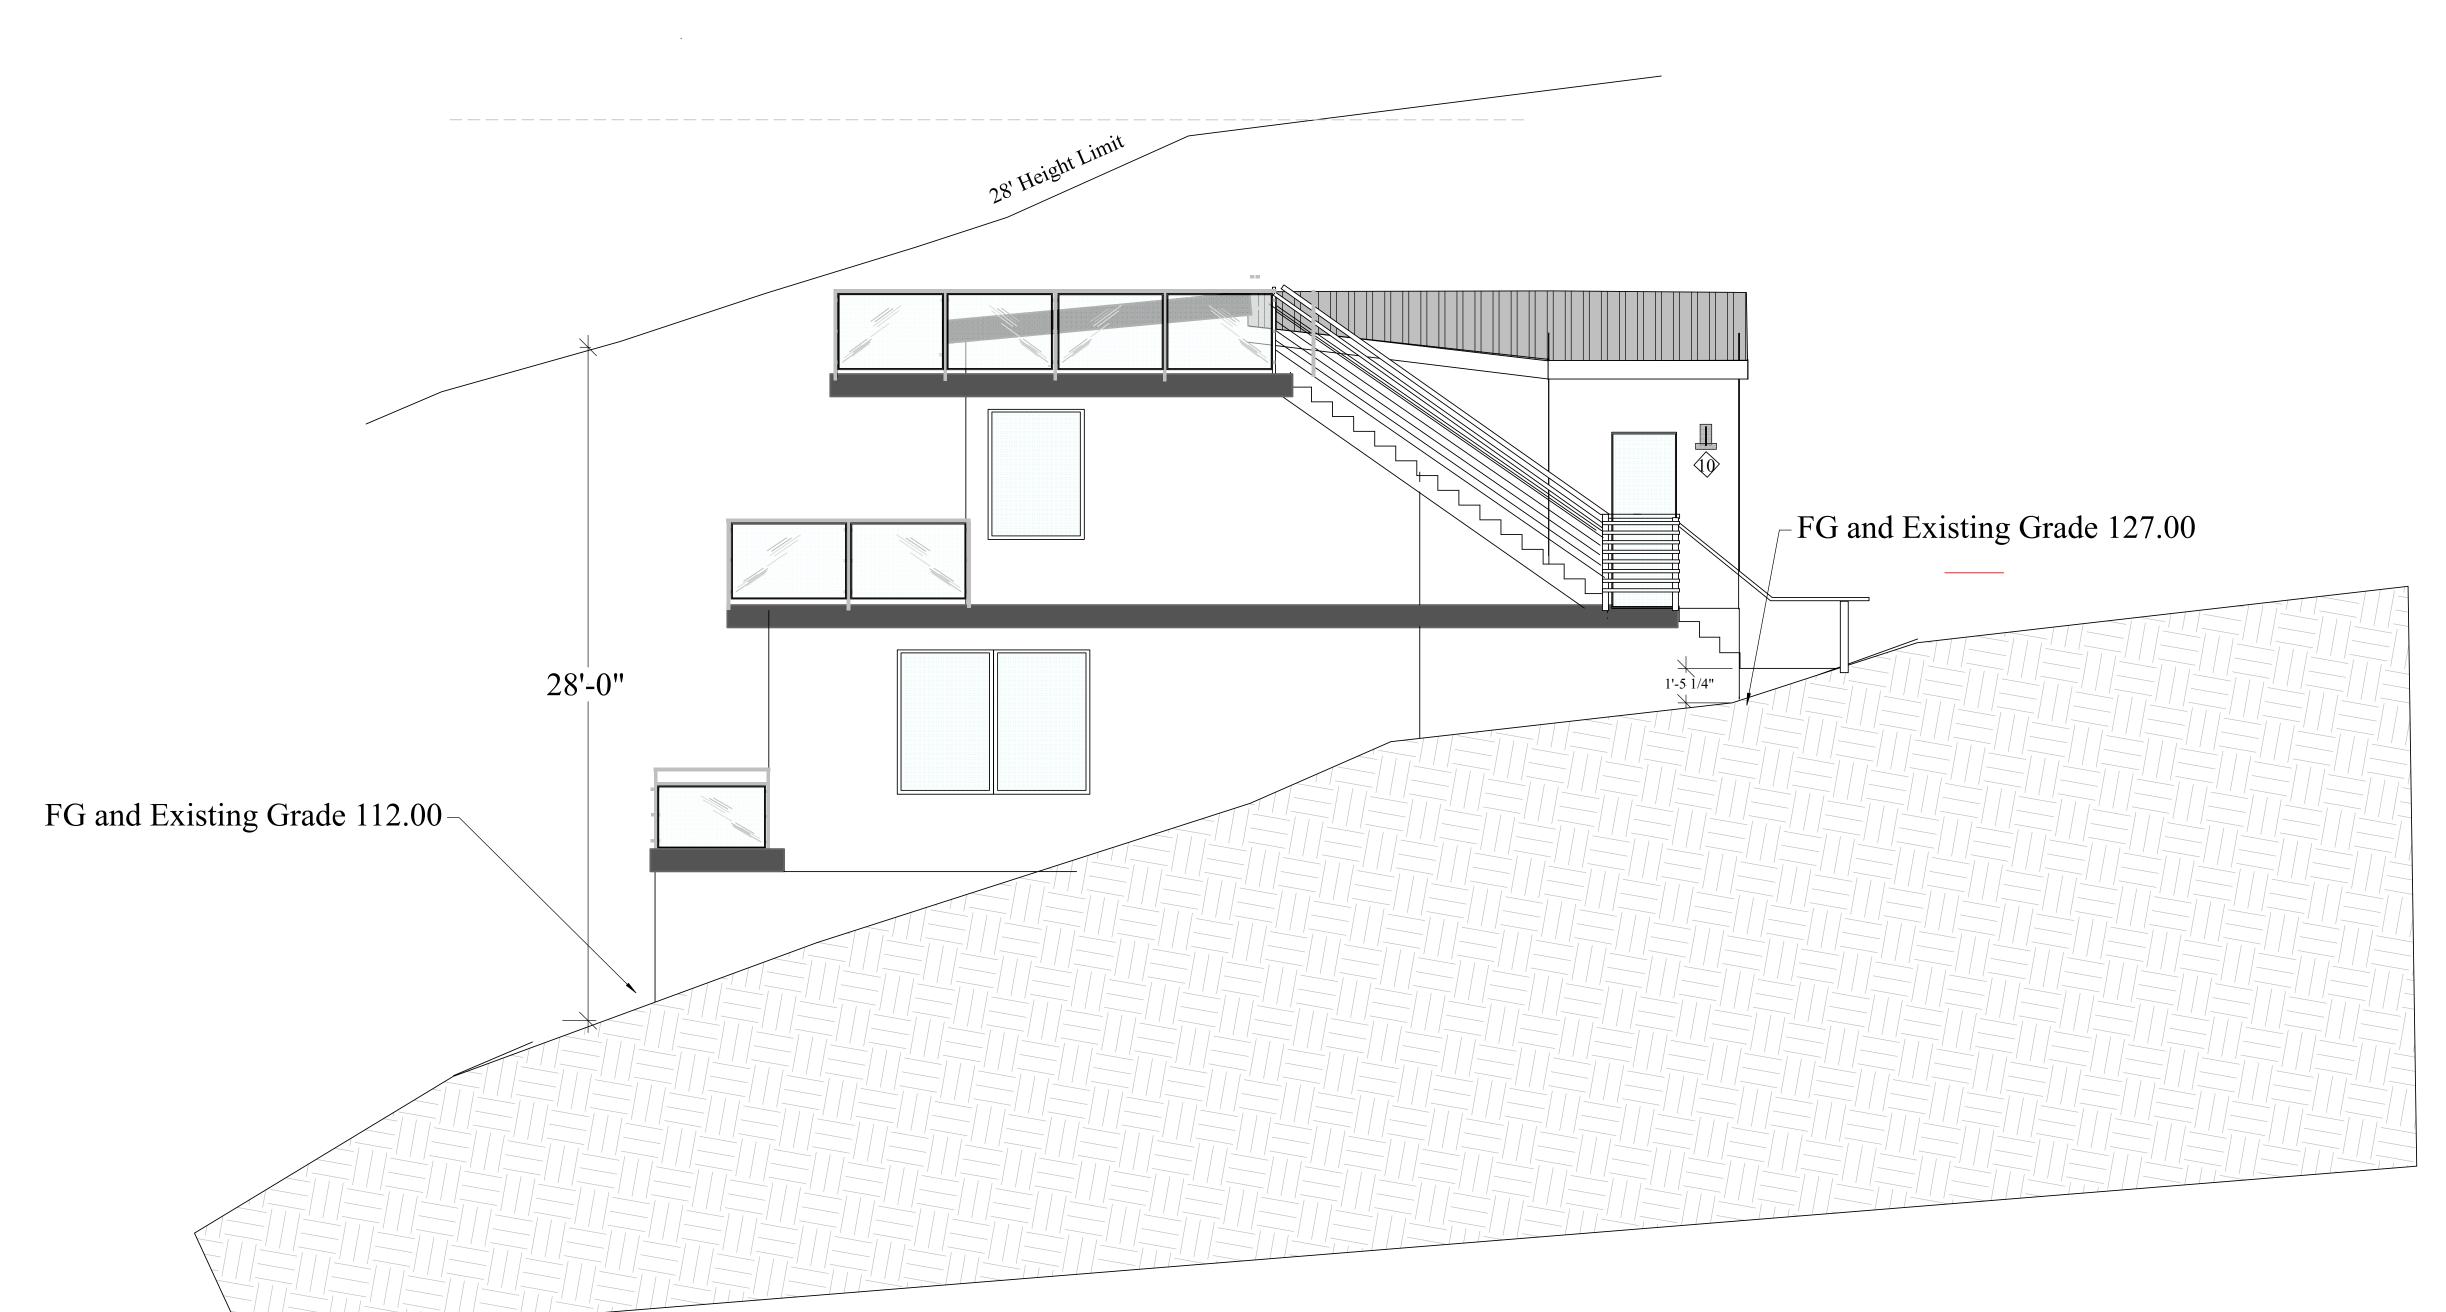
El Granada CAA

Drawn By Tim Pond CA Contractor's License # 931840

Drawn By TP Scale 1/4" = 1' Revisions

8.10.24 Planning Submittal

North Elevation A3.3



Alexis and Sarita Genest alexis genest@yahoo.com

OWNER:

alexis_genest@yahoo.com 530 Isabella Rd, Half Moon Bay, CA 94019 650.454.5889

Site Location

APN 047-192-060

Isabella Road

Designer: Tim Pond
Tim Pond Design and Construction
Phone 650.576.7177 timcpond@gmail.com

El Granada CAA

Drawn By Tim Pond CA Contractor's License # 931840

Drawn By TP Scale 1/4" = 1'

Revisions Date

Planning Submittal 8.10.24

East Elevation

Keyed Notes

Maxim Lighting Civic Dark Sky LED Outdoor Wall Sconce Medium size Typical at all doors (dark sky compiant)

1 A3.4 East Elevation

